
CONTACT NUMBERS

PLANNING AND ZONING CONTACT: CITY OF LANSING PHONE: 517-483-4048


ENGINEERING/PUBLIC SERVICE CONTACT: CITY OF LANSING PHONE: 517-483-4455

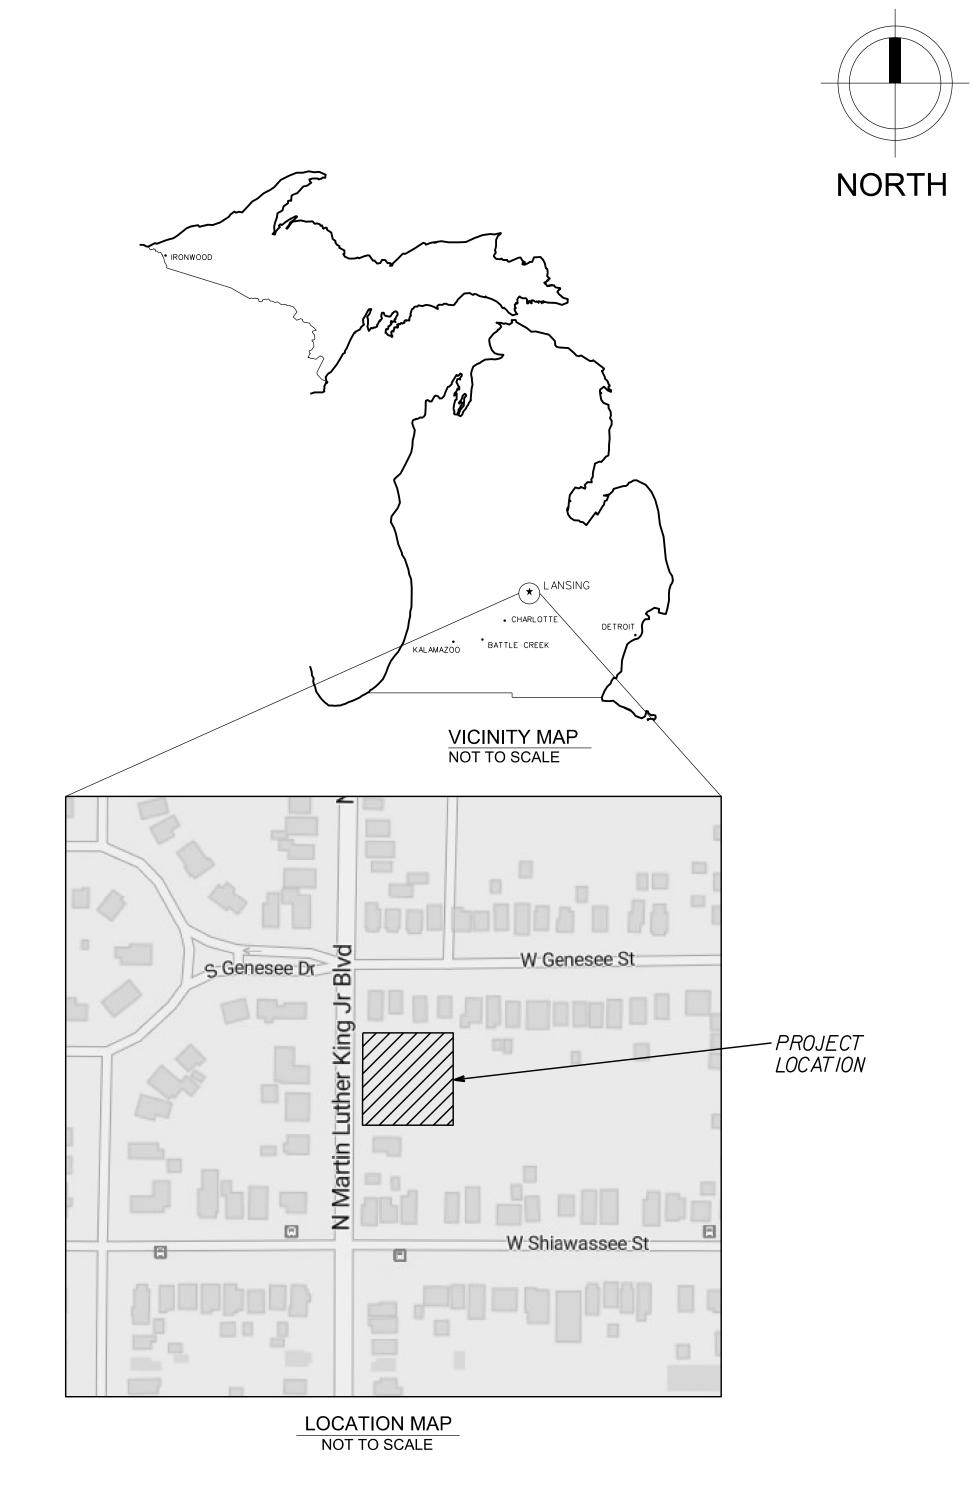

INGHAM COUNTY LAND BANK GENESEE POINTE CONDOMINIUMS

LOCATED IN

CITY OF LANSING, INGHAM COUNTY, MICHIGAN

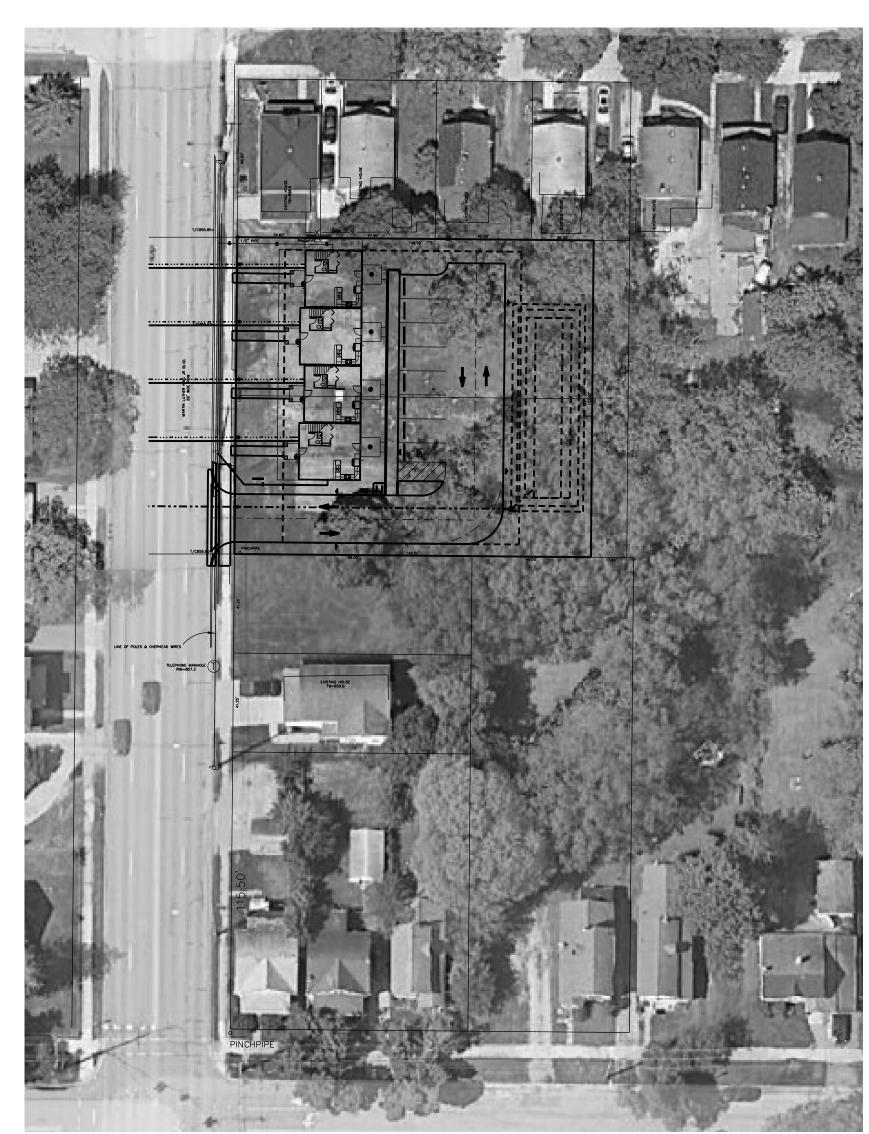

SITE LAYOUT NOT TO SCALE

N. MARTIN LUTHER KING JR BLVD ROW: THE CITY OF LANSING
IS SLATED TO HAVE A SEWER SEPARATION PROJECT OCCURING IN NEAR FUTURE.
COORDINATION WITH ON-GOING CONSTRUCTION AND ACCESS WILL BE REQUIRED.

ALL WORK WITHIN THE N. MARTIN LUTHER KING JR BLVD ROW

SHALL BE COMPLETED IN ACCORDANCE WITH MDOT &

THE CITY OF LANSING RULES, REGULATIONS,

AND GUIDELINES AND AS PERMITTED THEREIN

CITY OF LANSING NOTES:

ALL BROKEN AND DAMAGED SIDEWALK ALONG THE PROPERTY RIGHT OF WAY SHALL BE REMOVED AND REPLACED BY OWNER. ALL EXISTING SIDEWALK ON THE PROPOSED SITE DETERMINED TO NOT BE ADA COMPLIANT SHALL BE REMOVED AND REPLACED BY OWNER. SIDEWALK REPLACEMENT SHALL BE ACCORDING TO DETAILS THESE PLANS AND THE CITY OF LANSING STANDARDS.

THE CONTRACTOR SHALL OBTAIN A CITY PERMIT FOR ALL ROAD CUTS WHICH WILL BE BACK FILLED PER CITY STANDARDS TO THE BASE COURSE COMPACTED FINISHED GRADE. HMA PAVEMENT WILL BE REPLACED BY THE CITY AT A PRE-ESTABLISHED PER SQUARE UNIT COST.

CONTRACTOR SHALL OBTAIN CITY PERMIT FOR ALL CONCRETE WORK INCLUDING CURB AND GUTTER, DRIVE APPROACHES AND SIDEWALKS.

LINE-TYPE LEGEND

(COLC	SYMBOLS DRS ARE REPRESENTED ACCORDING TO MISS DIG)	DESCRIPTION (LINE WEIGHT .0004 UNLESS NOTED OTHERWISE)	
<u> </u>		ROAD RIGHT OF WAY CONTINUOUS CENTER LINE OF ROAD CENTER	
		PROPERTY LINE DASHDOT	
		GAS MAIN HIDDEN	
	CATV	CABLE TV HIDDEN	
	<u>E</u> E	UNDERGROUND ELECTRIC HIDDEN	
		UNDERGROUND TELEPHONE HIDDEN	
		FIBER OPTICS HIDDEN	
	834.0	NEW CONTOUR LINE (THIN BLACK LINE)	
	829.5	EXISTING CONTOUR LINE (GRAY COLOR)	
		WATER BOUNDRY	
	SAN SAN	PROP. SANITARY SEWER (BOLDEST (.50mm)) CONTINUOUS LINETYPE	
	ST ST	PROP. STORM SEWER (BOLD (.30mm)) HIDDEN LINETYPE	
	W	PROP. WATER MAIN (BOLDER (.40mm)) DIVIDED LINETYPE	
	<u>SAN</u> SAN	EX. SANITARY SEWER (.25mm) DASHED LINETYPE	
	ST ST	EX. STORM SEWER (.25mm) HIDDEN LINETYPE	
	. ·	EX. WATER MAIN (.25mm) DIVIDED LINETYPE	
		UTILITY EASEMENT HIDDEN LINETYPE	
		PROFILE LINE 10' OFF BASELINE	
		PROFILE LINE 20' OFF BASELINE	
		PROFILE LINE 30' OFF BASELINE	

		——5'-6"—— *
	, , '-0"	- ALUMINUM POST CAPS (3)
*		- DOUBLE RABBET POSTS.
<u>-</u>		INSTALL 3/8" X 7" H.D. GALV. THRU BOLT
*		
GROUND CO 6X6 CROS		
GALV, CHA	<i>X</i>	GENESEE POINTE
EYE BOLT TOP BEAM	INTO	CONDOMINIUMS
9 CLEVIS AT		420 N. MLK IR BLVD
		420 N. MER JR BEV D
44" X 30" SIGN PANE SCALLOPE CORNERS I BORDE TEXT FONT T.B.D.	L WITH D	GROUND CONTACT 6X6 POST. EMBED 30" IN CONC I6" X 48" CONC PIER IN SONOTUBE. I" EXPOSURE. POSITIVE SLOPE TOP FOR DRAINAGE
		FIN GRADE

BUILDING SIGNA
NOT TO SCALE

SHEET NO.	SHEET	REVISEI DATE
C0.0	COVER SHEET	03/20/23
S1.0	EXISTING SITE	03/20/23
C1.0	REMOVALS	03/20/23
C2.0	SITE LAYOUT PLAN	03/20/23
C3.0	GRADING & SESC PLAN	03/20/23
C3.1	STORM WATER CALCULATIONS	03/20/23
C4.0	UTILITY PLAN	03/20/23
C5.0	LANDSCAPE PLAN	03/20/23
C5.1	LIGHTING PLAN	03/20/23
C6.0	SPECIFICATIONS & DETAILS	03/20/23
C7.0	PLAN & PROFILE #6294 SAGINAW STREET	03/20/23




UNTY, MI


IFR

BRSE


GENESEE POINTE CONDOMINI
4-UNITS, 1 BUILDING
420 N. MARTIN LUTHER KING, JR. BLV
LANSING, INGHAM COUNTY, MI
COVER SHEET

PROJECT 0001

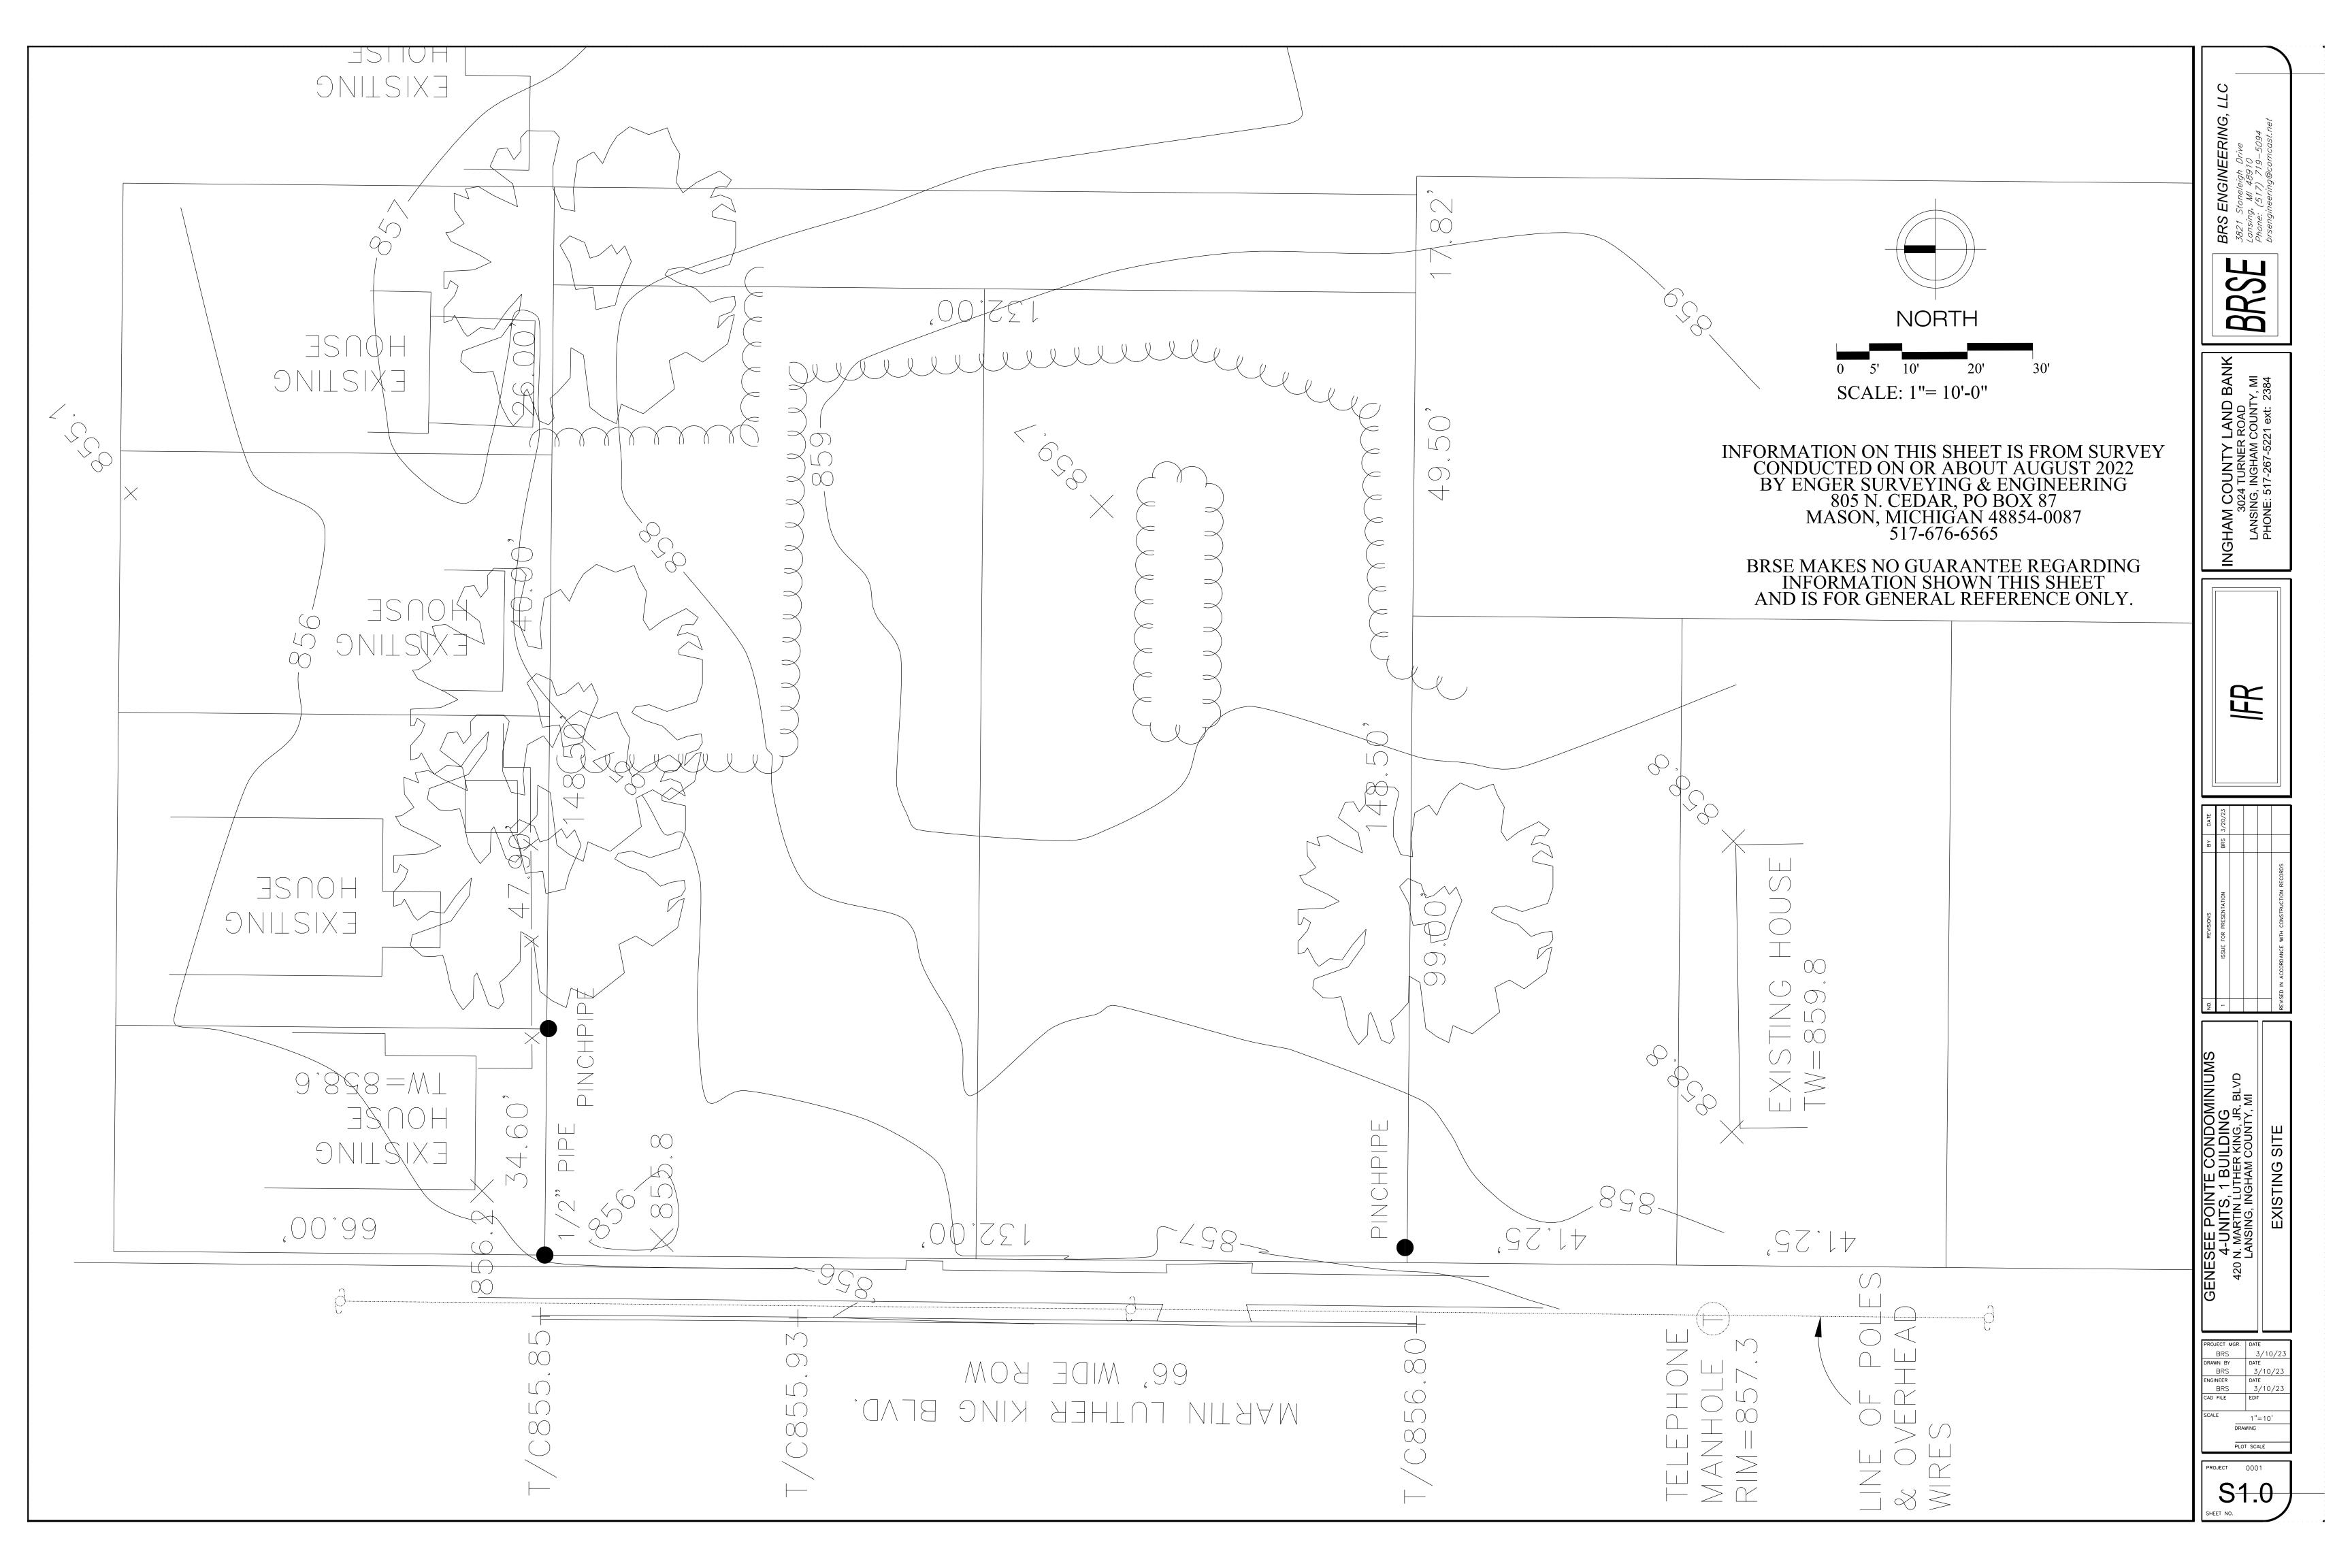


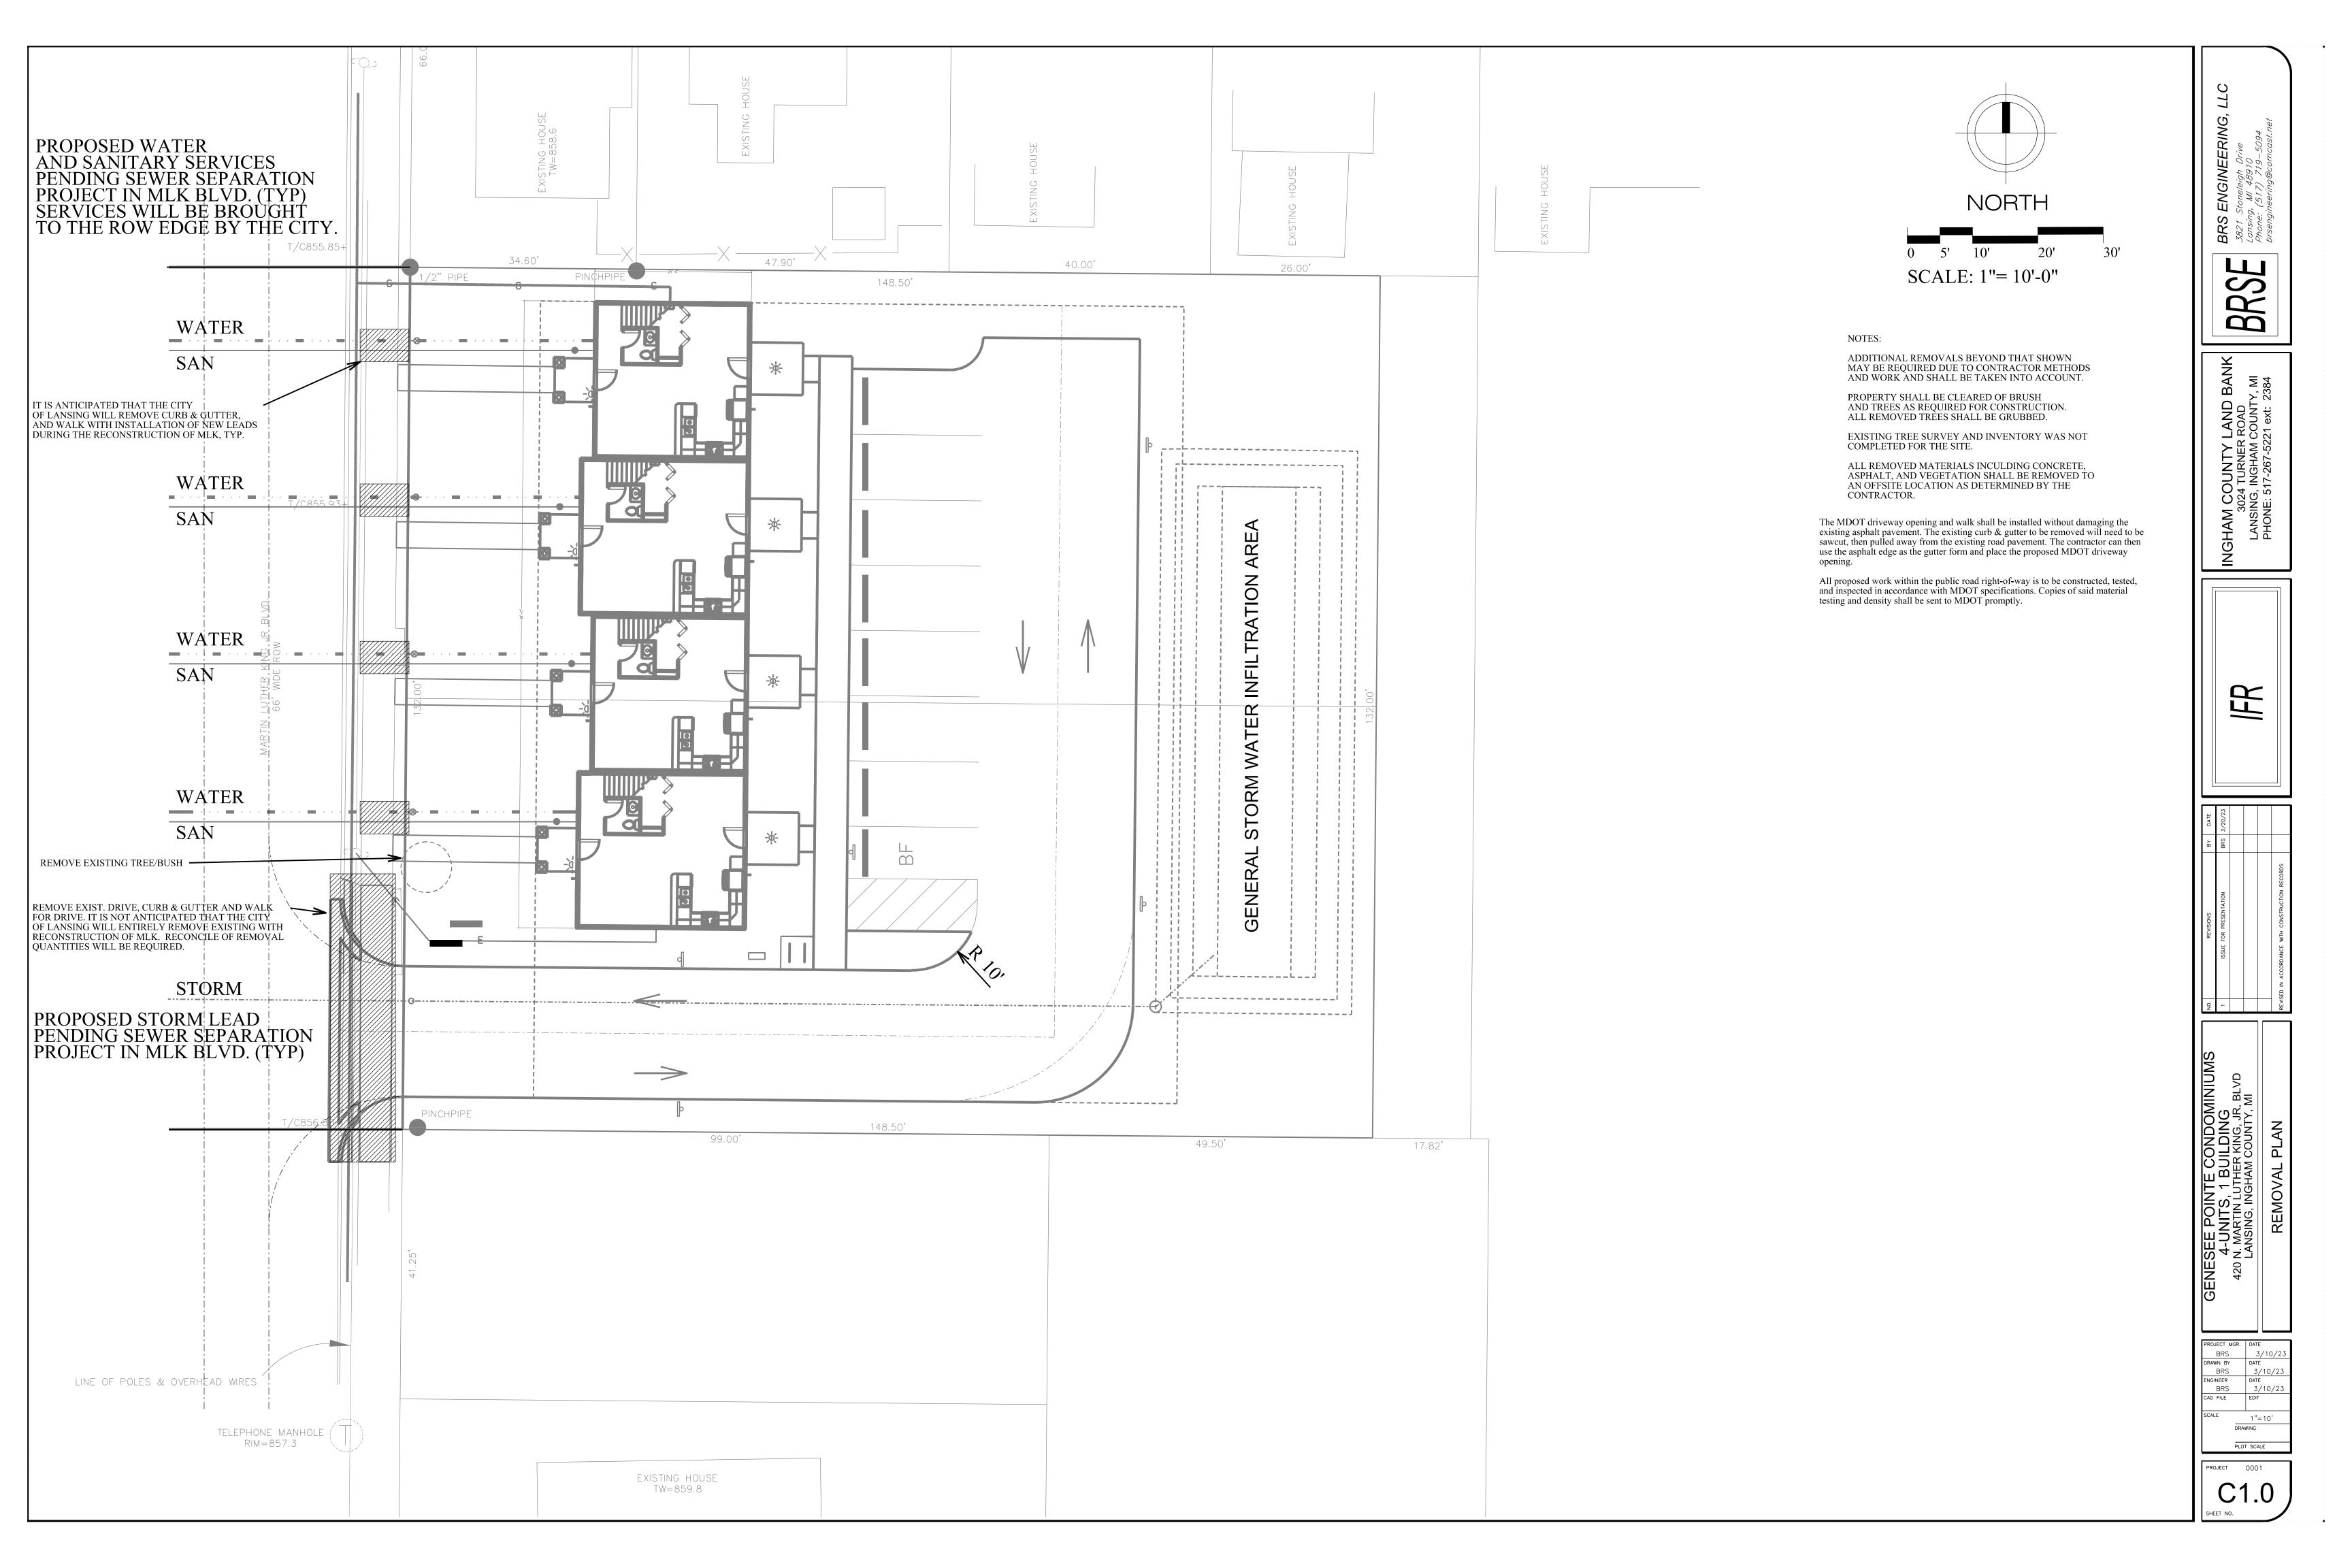



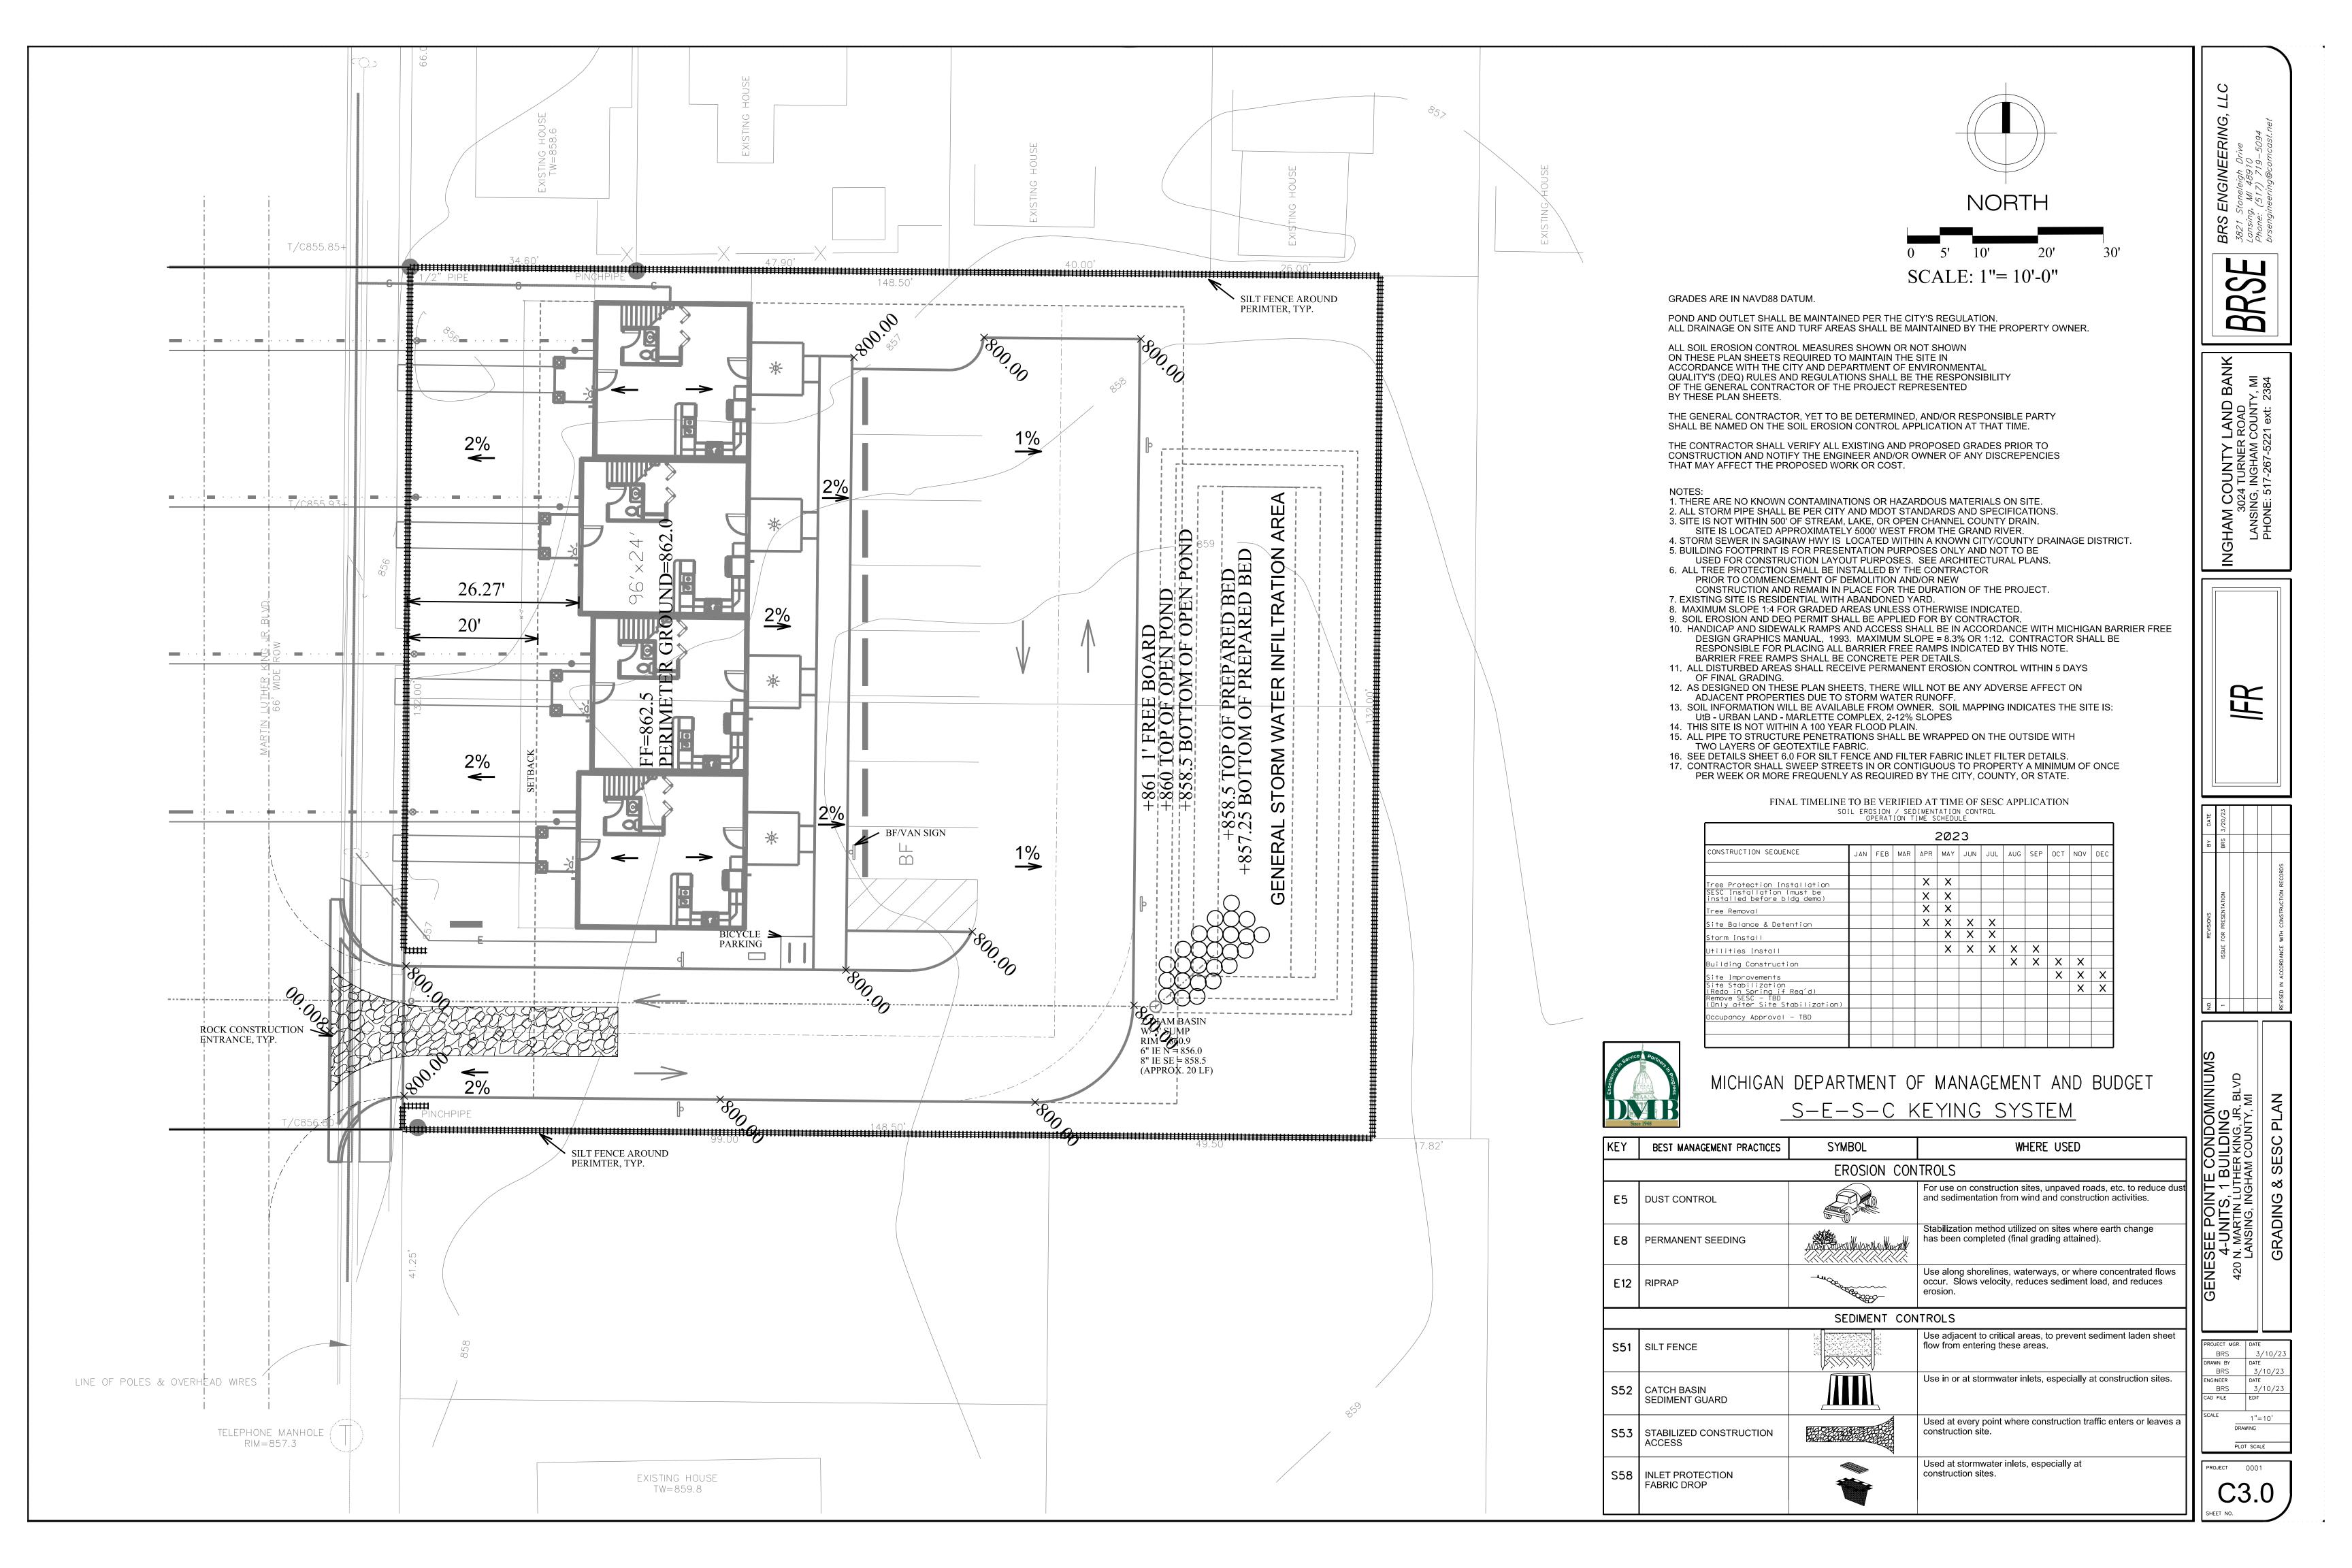

Master Site Development Stormwater Tool

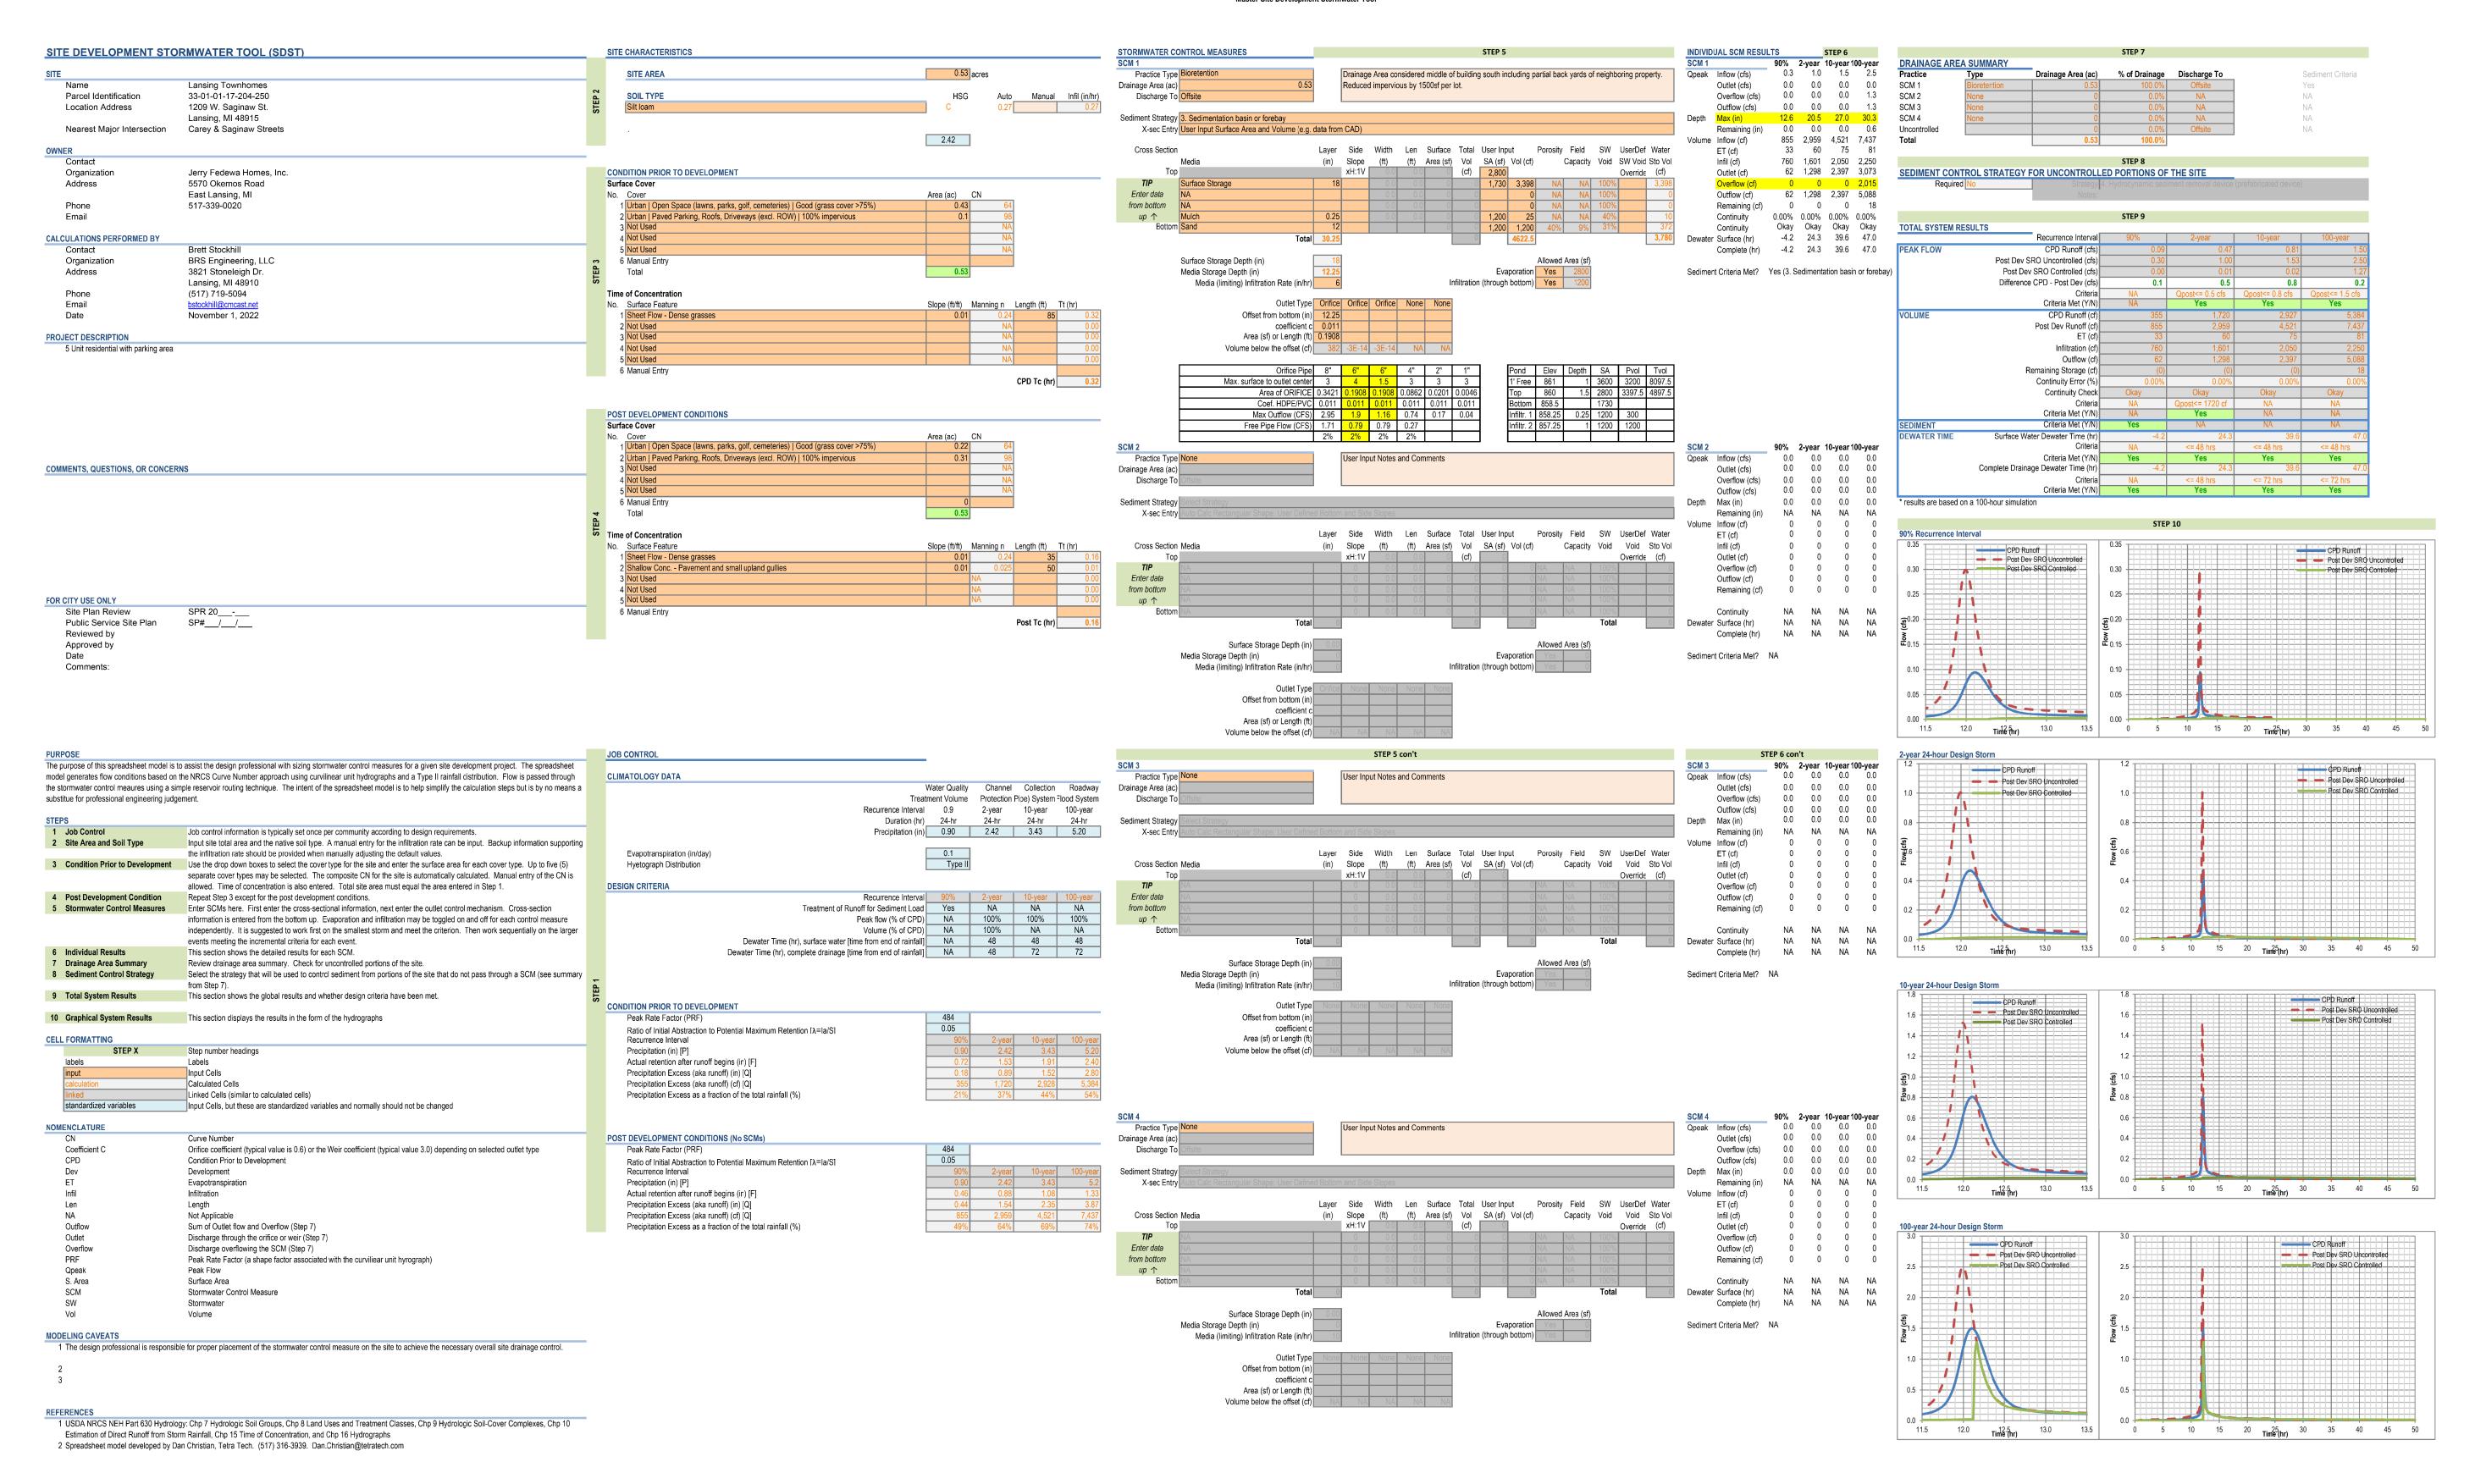

2/14/2023 SDST V04-35-Saginaw Rev3.xlsm

BRS ENGINEERING, LL 3821 Stoneleigh Drive Lansing, MI 48910 Phone: (517) 719–5094 brsengineering@comcast.net

BRSE

NGHAM COUNTY LAND BAN 3024 TURNER ROAD LANSING, INGHAM COUNTY, MI PHONE: 517-267-5221 ext: 2384

IFR

NO. REVISIONS BY DATE

1 ISSUE FOR PRESENTATION BRS 3/20/23

REVISED IN ACCORDANCE WITH CONSTRUCTION RECORDS

ENESEE POINTE CONDOMINIUMS
4-UNITS, 1 BUILDING
420 N. MARTIN LUTHER KING, JR. BLVD
LANSING, INGHAM COUNTY, MI
STORM WATER CALCULATIONS

 PROJECT MGR.
 DATE

 BRS
 3/10/23

 DRAWN BY
 DATE

 BRS
 3/10/23

 ENGINEER
 DATE

 BRS
 3/10/23


 CAD FILE
 EDIT


 SCALE
 1"=10'


PLOT SCALE

C3.1

Page 1 of 1

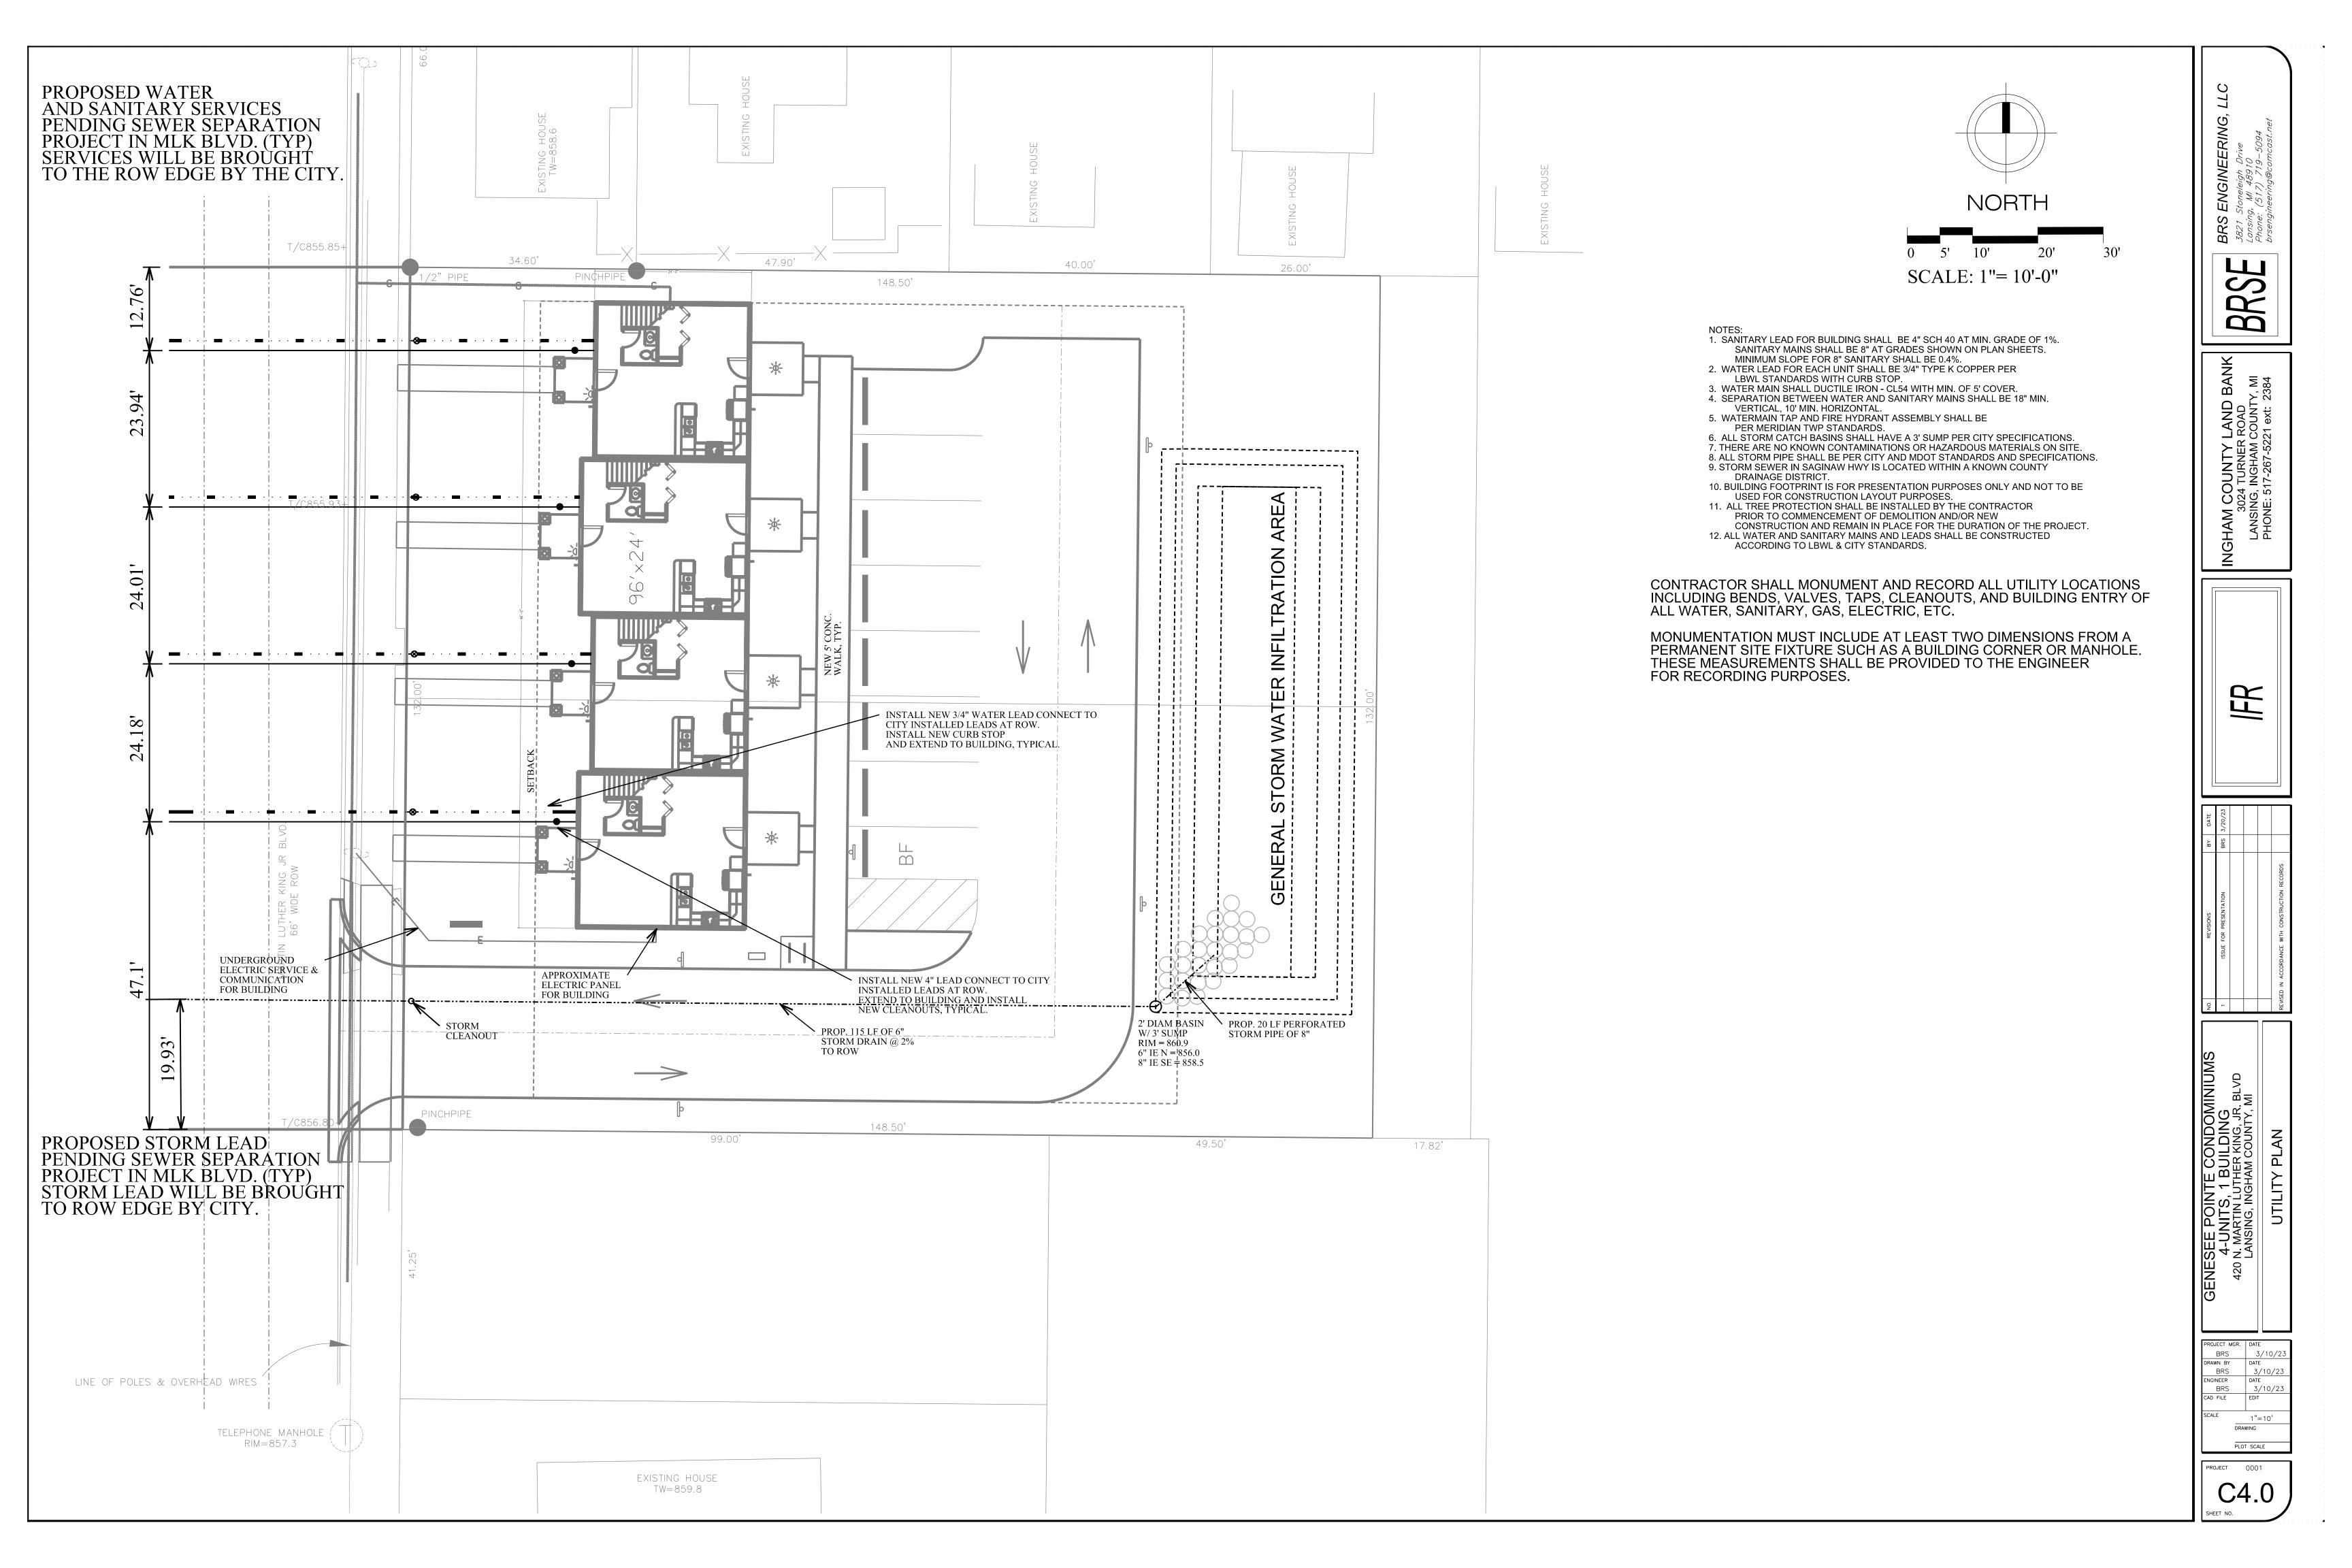

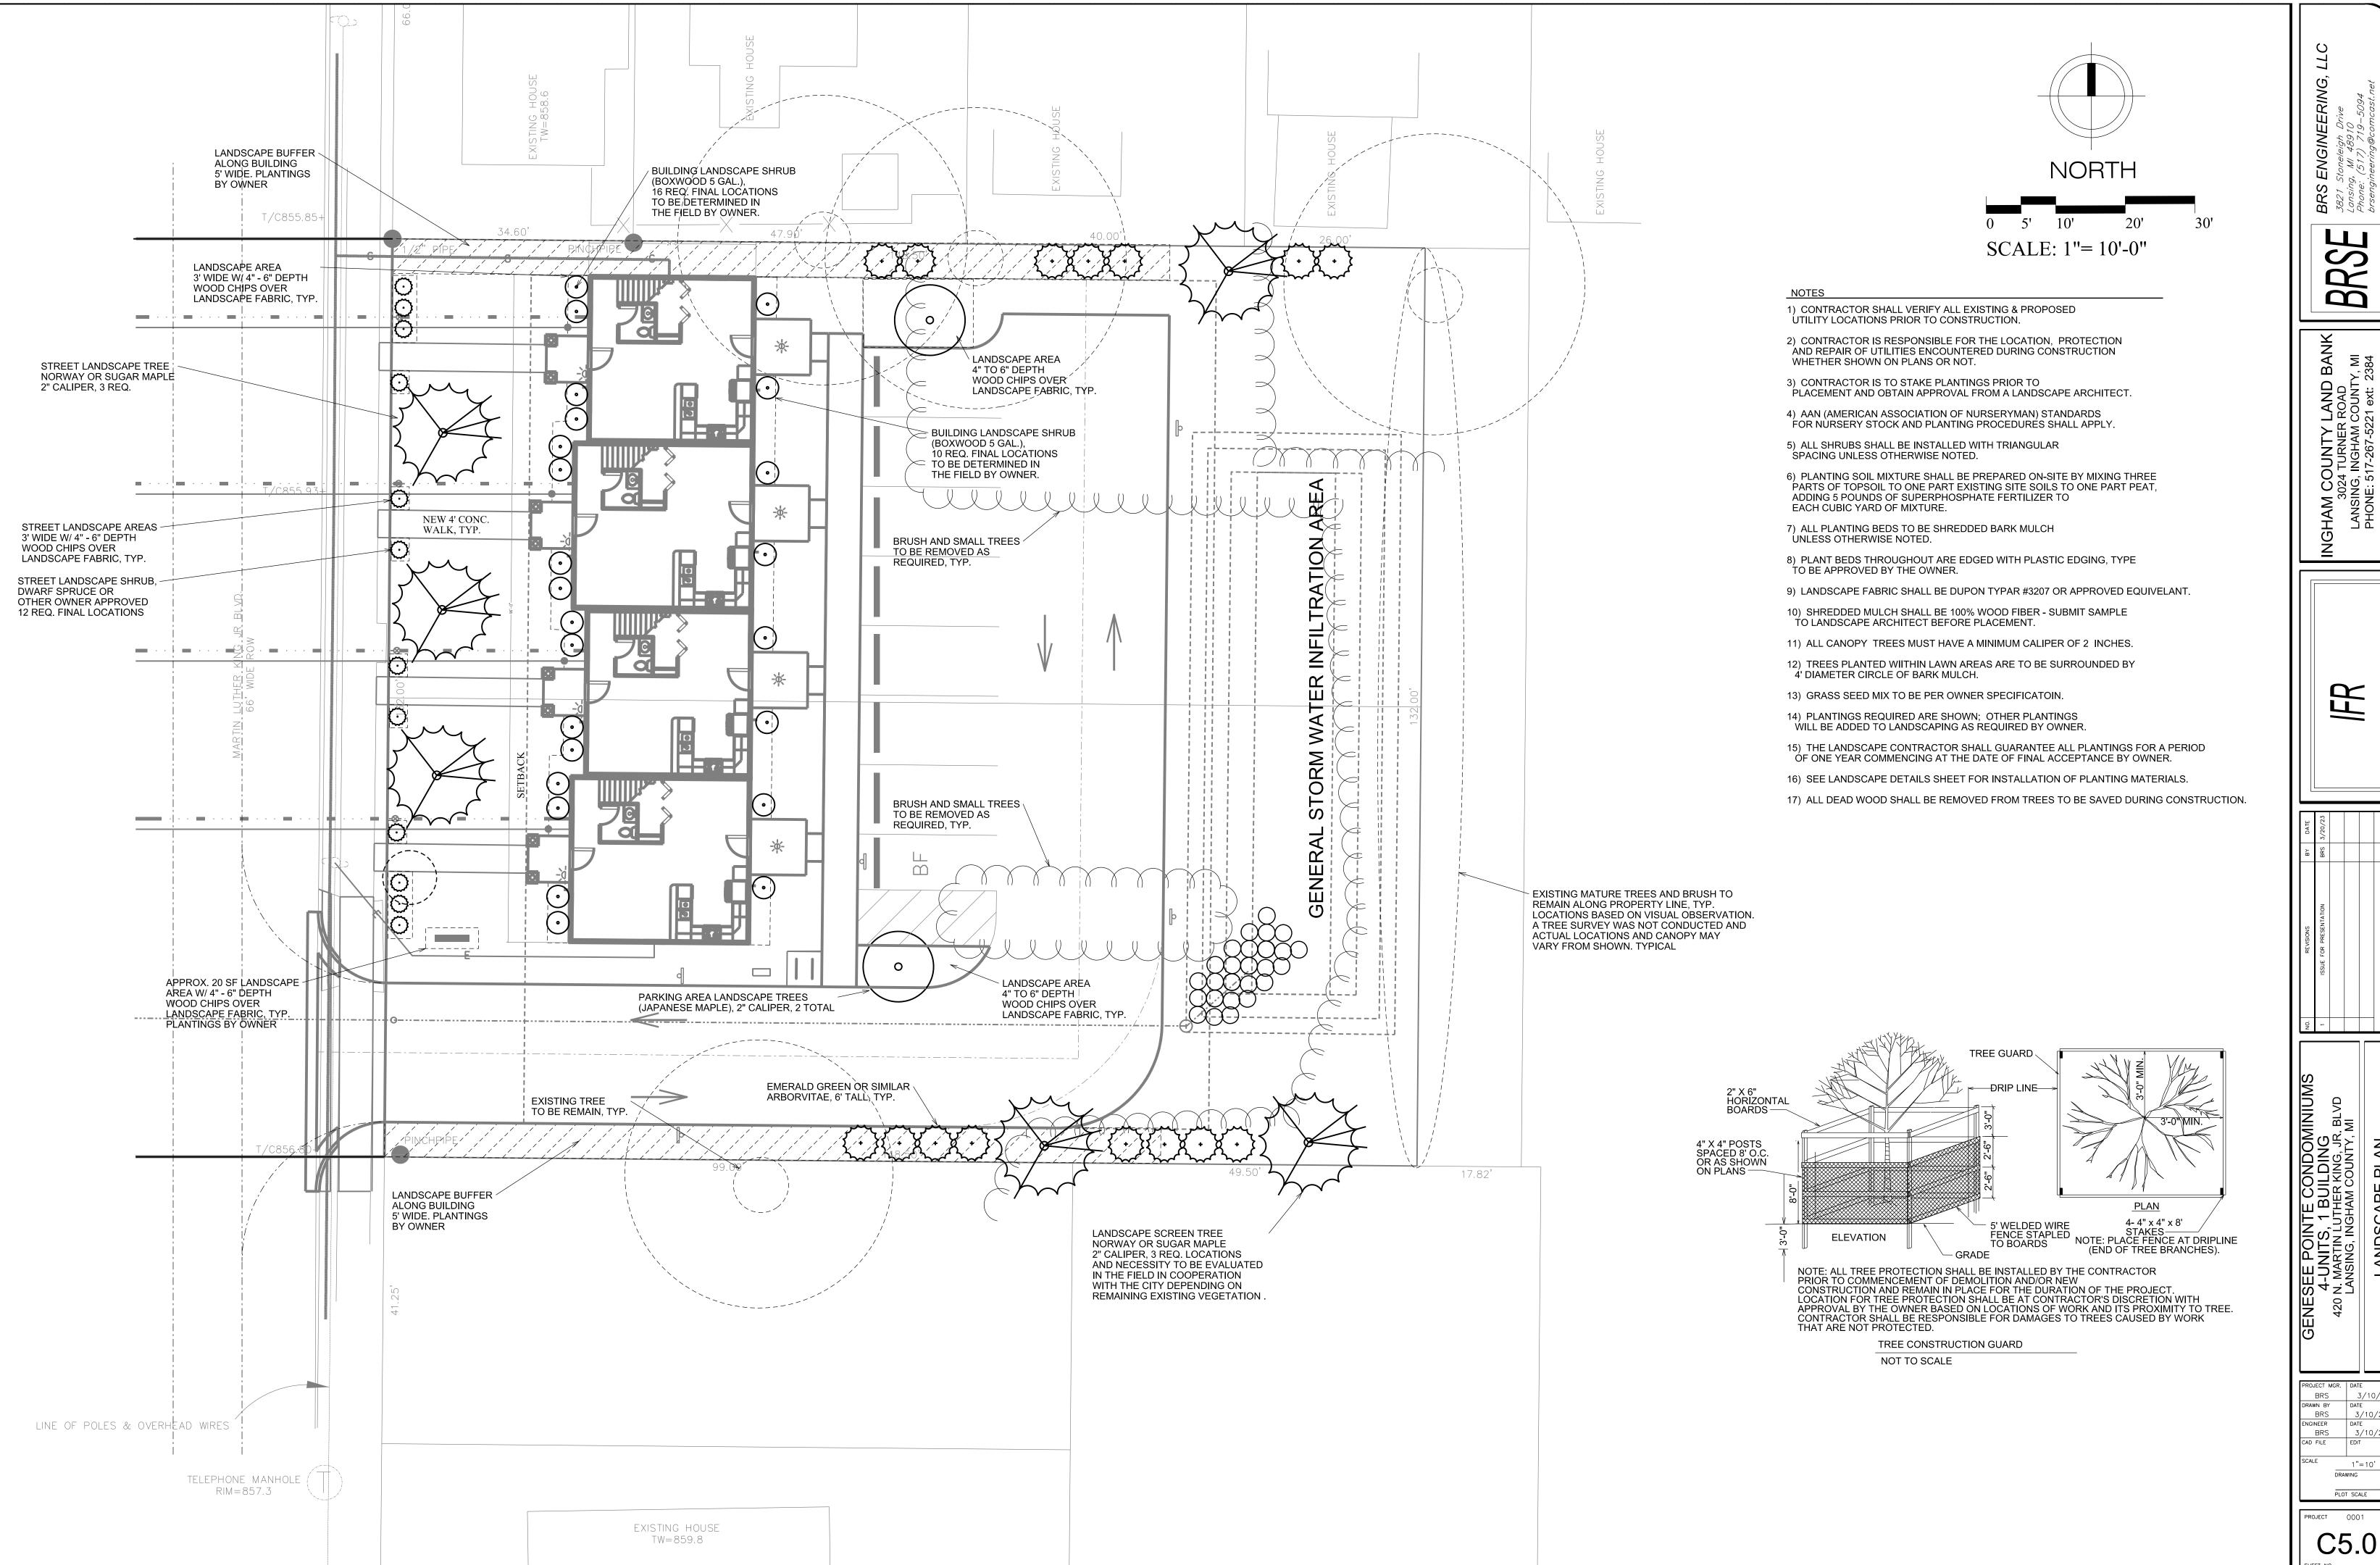

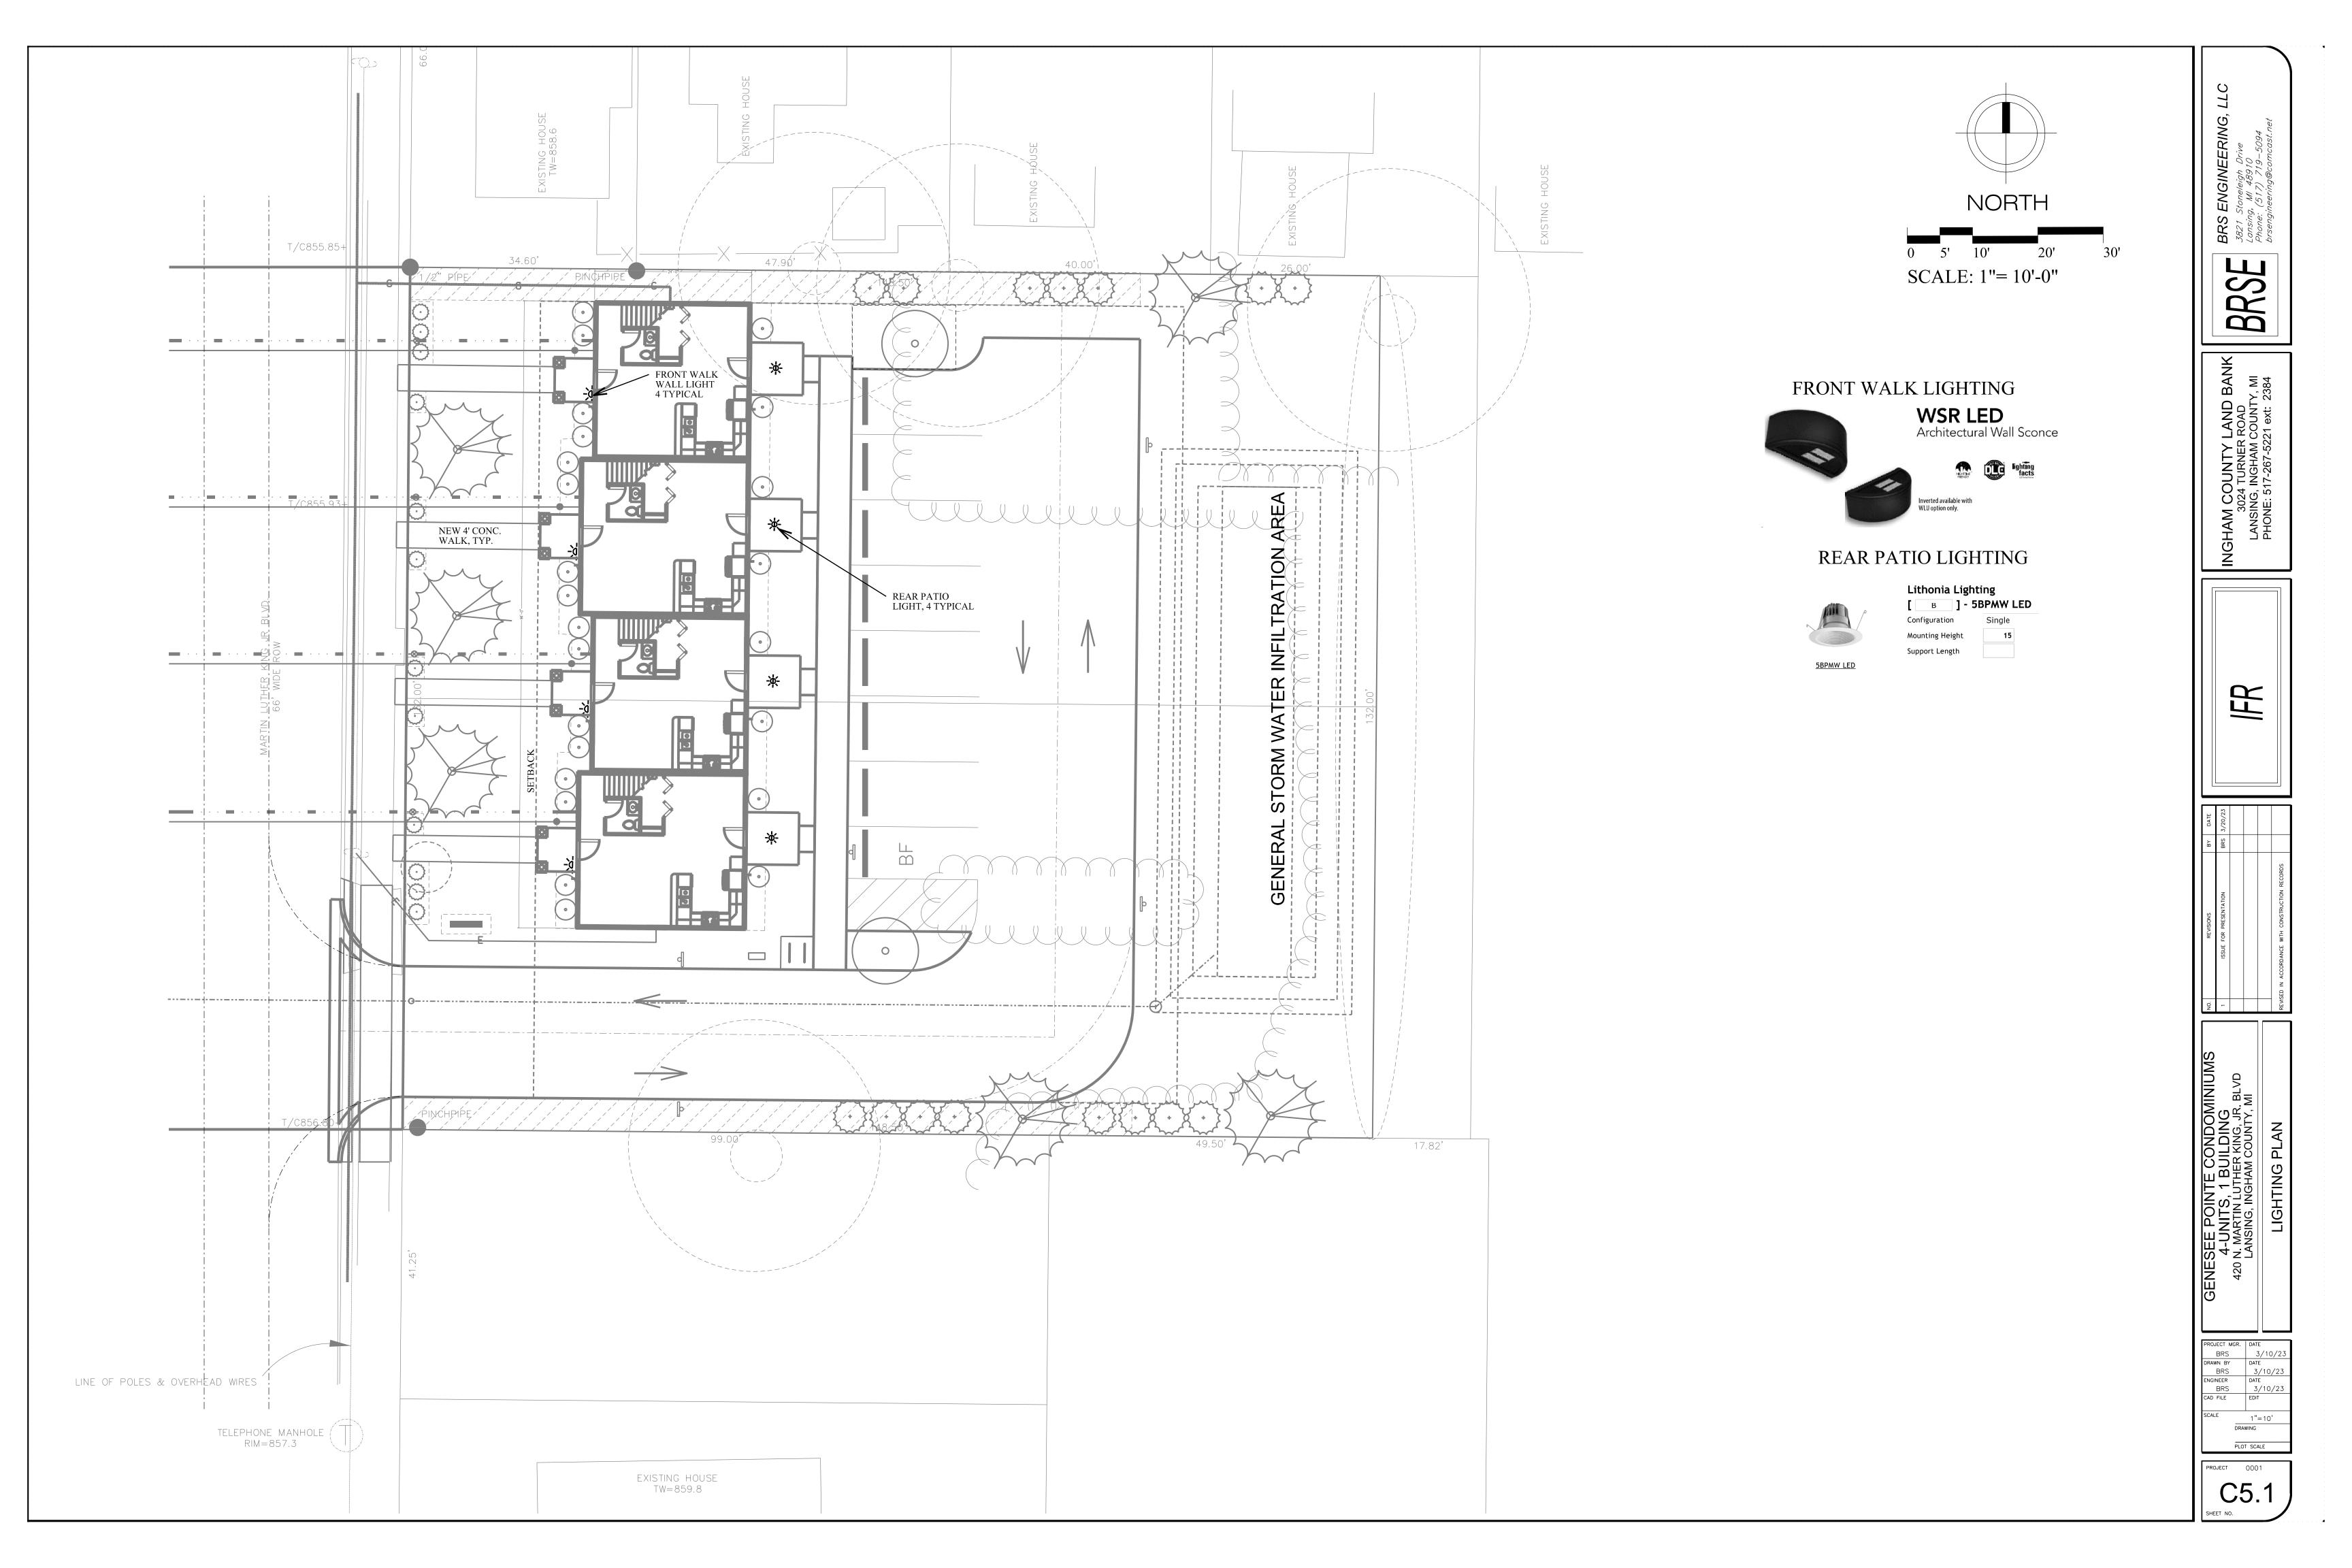

SPECIFICATIONS

GENERAL SPECIFICATIONS

1. FOR PROTECTION OF UNDERGROUND UTILITIES, THE CONTRACTOR SHALL DIAL 1-800-482-7171 A MINIMUM OF 72 HOURS PRIOR TO EXCAVATING IN THE VICINITY OF UTILITY LINES. ALL "MISS DIG" PARTICIPATING MEMBERS WILL THUS BE ROUTINELY NOTIFIED. THIS DOES NOT RELIEVE THE CONTRACTOR OF THE RESPONSIBILITY OF NOTIFYING UTILITY OWNERS WHO MAY NOT BE A PART OF THE "MISS DIG" ALERT SYSTEM.

2. INFORMATION ON DEPTH, SIZE AND ETC. OF ALL OTHER UNDERGROUND UTILITIES SHOWN HEREON IS PLAN INFORMATION ONLY, OBTAINED FROM THE UTILITY COMPANY INVOLVED OR FROM OBSERVATION. PRIOR TO ANY CONSTRUCTION, IT IS RECOMMENDED THAT ALL UTILITY COMPANIES, AGENCIES, DEPARTMENTS AND ETC. INVOLVED BE CONTACTED FOR VERIFICATION OF SUCH

3. THE LOCATION, SIZE AND ELEVATION OF SEWERS, WATER LINES AND RELATED STRUCTURES SHOWN HEREON WERE OBTAINED FROM EXISTING PLANS PREPARED BY OTHERS AND FIELD OBSERVATIONS. BRSENGINEERING, LLC. IS NOT RESPONSIBLE FOR ANY OTHER SEWERS, DRAINS, OR RELATED STRUCTURES NOT FOUND AND NOT SHOWN HEREON THAT MAY CROSS, PARALLEL, LIE

4. IT SHALL BE THE CONTRACTOR'S RESPONSIBILITY TO VERIFY, PRIOR TO BEGINNING CONSTRUCTION, ALL CRITICAL ELEVATIONS AND LOCATIONS OF UNDERGROUND UTILITIES. IF ELEVATIONS OR LOCATIONS ARE SUBSTANTIALLY DIFFERENT THAN SHOWN ON THE PLANS, THE ENGINEER SHALL BE NOTIFIED IMMEDIATELY.

5. ALL MATERIAL PLACED BELOW OR WITHIN THE INFLUENCE OF ROADS, CURBING, CONCRETE, PAVING OR ANY STRUCTURE SHALL BE COMPACTED TO 95% OF THE MATERIAL'S MAXIMUM UNIT WEIGHT BASED ON THE MODIFIED PROCTOR (ASTM D1557-70). IN AREAS OTHER THAN NOTED ABOVE, ALL MATERIAL SHALL BE COMPACTED TO 90% OF IT'S MAXIMUM UNIT WEIGHT.

6. ALL UTILITY BEDDING SHALL BE A MINIMUM OF CLASS "B" AS PER ASTM C-12, UNLESS OTHERWISE SPECIFIED ON THE PLANS. BEDDING SHALL BE CONSIDERED INCIDENTAL TO THE PLACING OF THE UTILITY. THE TYPICAL TRENCH DETAILS SHOWN ON THE MERIDIAN TOWNSHIP DETAILS SHALL BE USED FOR SANITARY SEWER AND WATER MAIN. THE TYPICAL TRENCH DETAIL ON THIS SHEET SHALL BE USED FOR ALL OTHER UTILITIES.

7. ALL FACILITIES AND GROUNDS DAMAGED BY CONSTRUCTION SHALL BE REPAIRED AND RETURNED AS NEARLY AS POSSIBLE TO THEIR CONDITION PRIOR TO THIS CONSTRUCTION. THIS SHALL BE THE CONTRACTOR'S RESPONSIBILITY.

8. UPON COMPLETION OF GRADING, ALL DISTURBED AREAS SHALL BE COVERED WITH A MINIMUM OF 4" OF TOPSOIL AND THEN SEEDED AND MULCHED.

9. UPON COMPLETION OF CONSTRUCTION, THE CONTRACTOR SHALL REMOVE ALL MUD AND DEBRIS FROM SEWERS, MANHOLES, CATCH BASINS AND RELATED STRUCTURES.

10. IT SHALL BE THE CONTRACTOR'S RESPONSIBILITY TO SCHEDULE CONSTRUCTION IN SUCH A MANNER AS TO MINIMIZE INCONVENIENCE TO RESIDENTS DUE TO INTERRUPTIONS IN SEWER OR WATER SERVICE OR BLOCKAGE OF STREETS.

SANITARY SEWER LEADS

1. ALL SANITARY SEWER LEADS SHALL BE 6" AND LAID TO A MINIMUM SLOPE OF 1.00%.

WATER SERVICE

1. ALL WATER LEADS SHALL BE 1.25" TYPE K COPPER.

- 1 1/2"LIFTS.

. ALL STORM SEWER CONSTRUCTION SHALL COMPLY WITH THE CONSTRUCTION STANDARDS OF THE CITY AND SHALL BE SUBJECT TO THEIR INSPECTION AND APPROVAL

2. ALL DRAINAGE STRUCTURES SHALL BE THE MATERIAL AS SPECIFIED IN PLAN DETAILS. THE BASE OF ALL STRUCTURES SHALL BE PLACED ON A BED OF 4" OF COMPACTED SAND.

3. STORM SEWER PIPE SHALL BE GALVANIZED CMP AS SPECIFIED ON PLANS. ALL JOINTS SHALL BE WRAPPED IN GEOTEXTILE MATERIAL.

ROADS, PARKING AND CONCRETE

1. ALL WORK WITHIN THE ROAD RIGHT-OF-WAY SHALL COMPLY WITH THE CONSTRUCTION STANDARDS AND SPECIFICATIONS OF MDOT (INCLUDING BUT NOT LIMITED TO MATERIALS AND THICKNESSES). NO WORK SHALL BE PERFORMED WITHIN THE ROAD RIGHT-OF-WAY UNTIL THE APPROPRIATE PERMITS ARE OBTAINED. IT SHALL BE THE CONTRACTORS RESPONSIBILITY TO OBTAIN ALL

2. ALL EXISTING THICKNESSES OF MATERIALS WITHIN PUBLIC ROADWAYS SHALL BE MATCHED DURING THE RECONSTRUCTION WITHIN THE ROAD RIGHT OF WAY.


3. ANY UNDESIRABLE MATERIAL ENCOUNTERED BENEATH THE ROAD, DRIVEWAY, PARKING LOT OR BUILDING SHALL BE REMOVED AND REPLACED WITH SATISFACTORY MATERIAL PLACED IN 6" LAYERS AND COMPACTED TO 95% OF ITS MAXIMUM UNIT WEIGHT.


4 CURB AND GUTTER SHALL BE AS SHOWN ON THE PLANS. CURB AND GUTTER SHALL CONTAIN TWO 1/2" STEEL REINFORCING BARS PLACED AS SHOWN. CONCRETE SHALL BE GRADE 35S OR 35P WITH A 28 DAY STRENGTH OF 3500 P.S.I. IN ACCORDANCE WITH M.D.O.T. SPECIFICATIONS SEC. 6.09.

5. CURB AND GUTTER IN ROAD RIGHT OF WAY SHALL HAVE 11" OF COMPACTED CLASS 2 SAND PLACED BELOW IT. CURB AND GUTTER IN PARKING AREA SHALL HAVE A MINIMUM OF 4" OF COMPACTED CLASS 2 SAND PLACED BELOW IT.


6. ALL INTERSECTIONS OF SIDEWALKS, DRIVES AND PARKING AREAS AT THE SHOWN BARRIER FREE RAMP LOCATIONS SHALL COMPLY WITH BARRIER FREE REQUIREMENTS.


7. THE PARKING AND DRIVE AREAS SHALL HAVE THE FOLLOWING: GRADING AND COMPACTION OF THE SUBGRADE, A MINIMUM OF 8" OF COMPACTED CLASS 2 SAND SUB-BASE, A MINIMUM OF 6" OF 22A ROAD GRAVEL BASE AND 3" OF BITUMINOUS PAVING PLACED IN 2

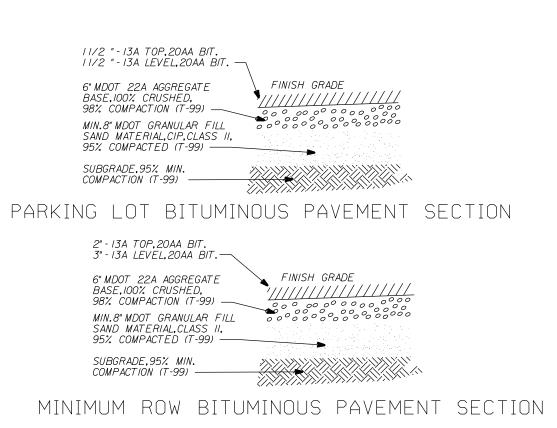


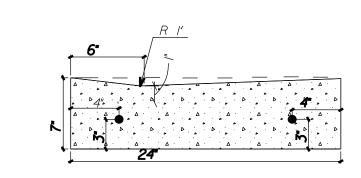



GUTTER PAN DETAIL

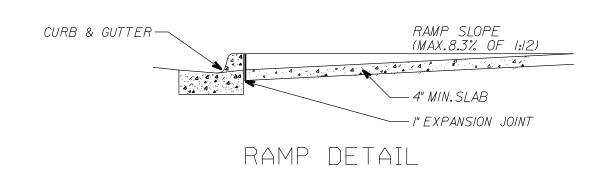

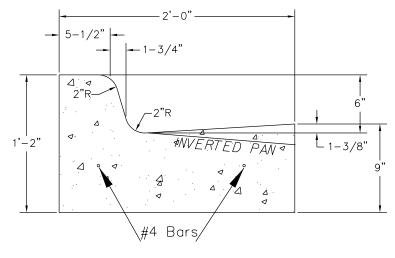


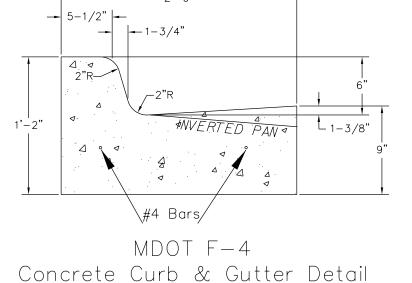

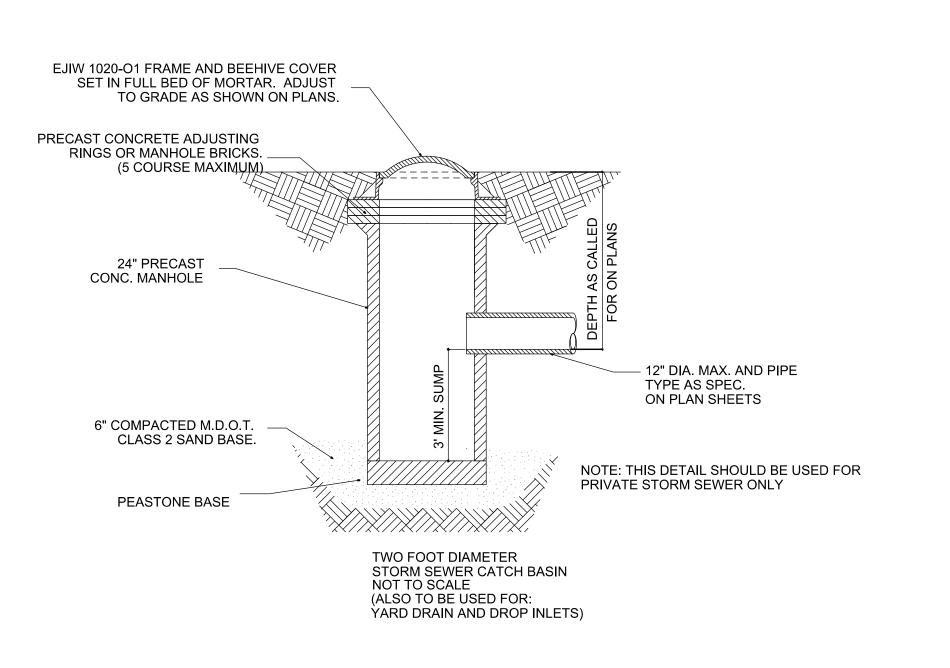


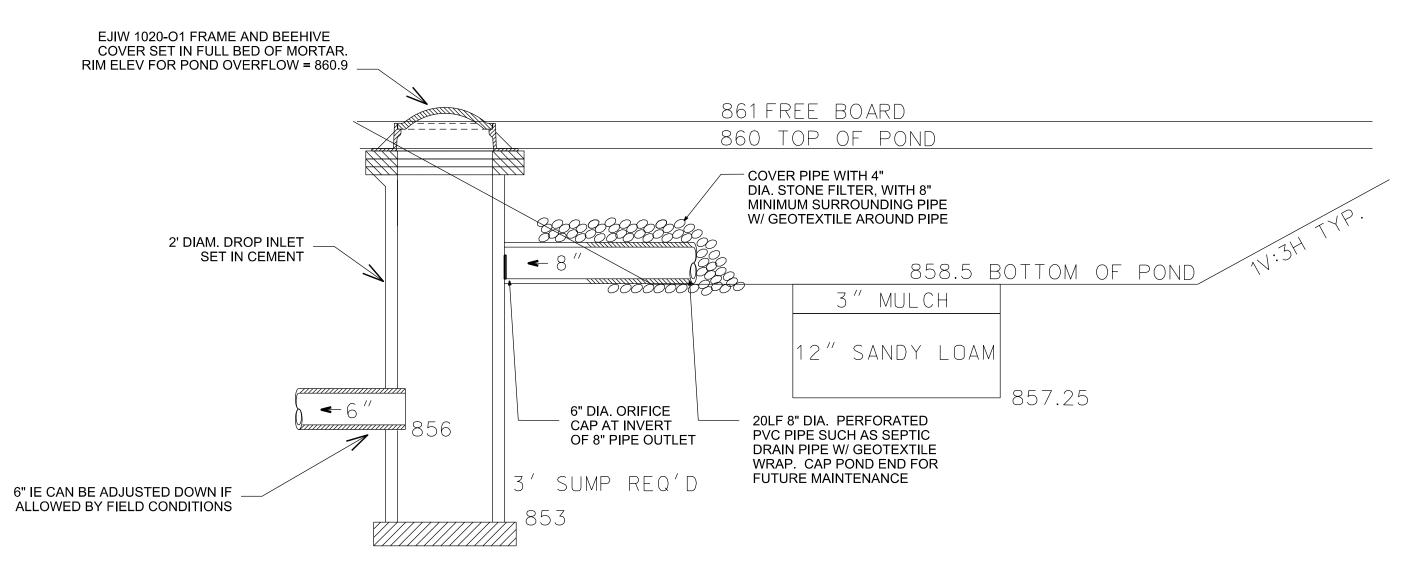

BIORETENTION SECTION

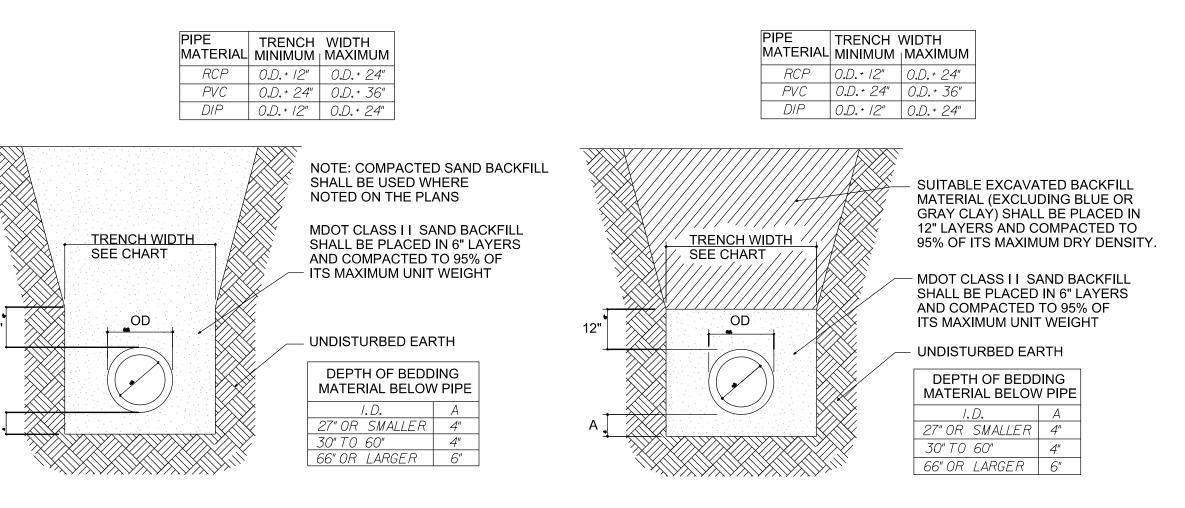

EXCAVATED MATERIAL BACKFILL (FOR USE IN NON-PAVEMENT AREAS)

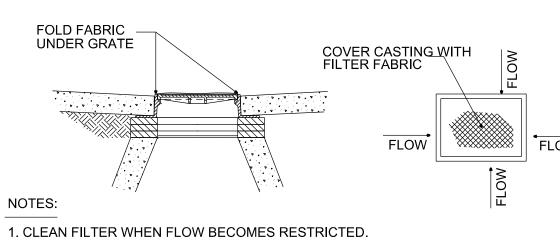

PIPE BEDDING AND BACKFILL DETAIL


SCALE: NO SCALE


2. FILTER FABRIC SHALL BE OF THE FOLLOWING OR AN APPROVED EQUIVALENT: A) MIRAFI (NON-WOVEN) - CELANESE FIBERS MARKETING CO. B) POLYFILTER X (WOVÉN) - CARTHAGE MILLS C) TYPAR (NON-WOVEN) - DUPONT COMPANY D) OR APPROVED EQUAL

3. ALL MANHOLES, CATCH BASINS, AND CURB INLETS TO BE PROTECTED WITH THE FILTER FABRIC INLET FILTER SHOWN ABOVE.

4. REGULAR MAINTANCE OF FILTERS SHALL BE PER SCHEDULE SET FORTH IN SOIL EROSION CONTROL PERMITS.

> FILTER FABRIC INLET FILTER SCALE: NO SCALE

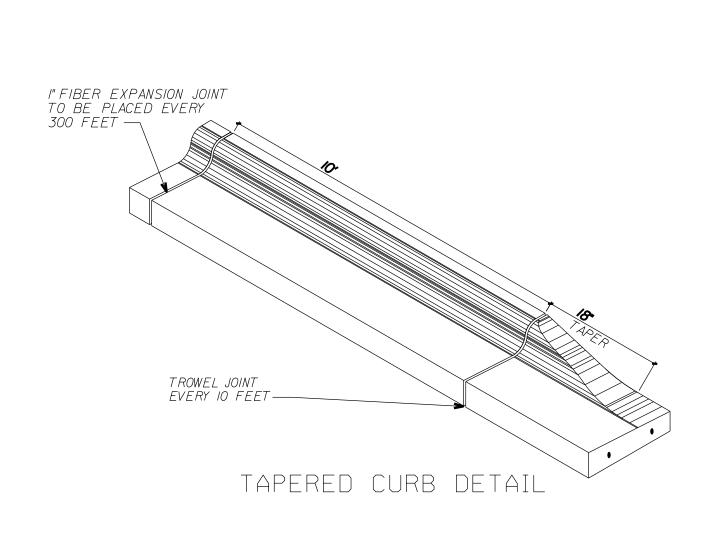

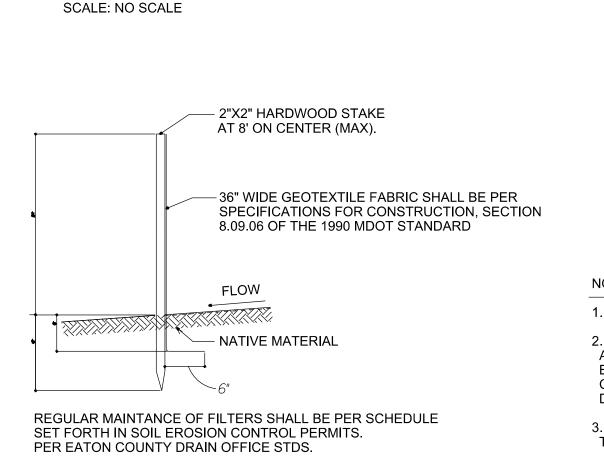

COMPACTED SAND BACKFILL

(FOR USE UNDER PAVEMENT AREAS)

PIPE BEDDING AND BACKFILL DETAIL

SILT FENCE SCALE: NO SCALE BRS 9/ DRAWN BY DATE

BRS 9/8/22
ENGINEER DATE
BRS 9/8/22
CAD FILE EDIT 1"=10'

S

BR

PLOT SCALE ROJECT 0001